

NOTES:

 ALL MOOD EXPOSED TO WEATHER SHALL BE PRESSURE TREATED, PAINTED OR CEDAR.

 CAULK AND SEAL ALL WINDOW/DOOR AND EXTERIOR ENVELOPE PENETRATIONS.

3. GLAZING PER STATE ENERGY CODE.


4. PROTECTION FROM DECAY IS REQUIRED FOR ALL WOOD SIDING AND WALL FRAMING LESS THAN 2" ABOVE CONCRETE STEPS, PORCH SLABS, PATIO SLABS, AND SIMILAR HORIZONTAL SURFACES EXPOSED TO THE WEATHER

PER MFG. SPECS

5. REFER TO ALL ELEVATIONS FOR TYPICAL NOTES.

6. S.G. = SAFETY GLASS



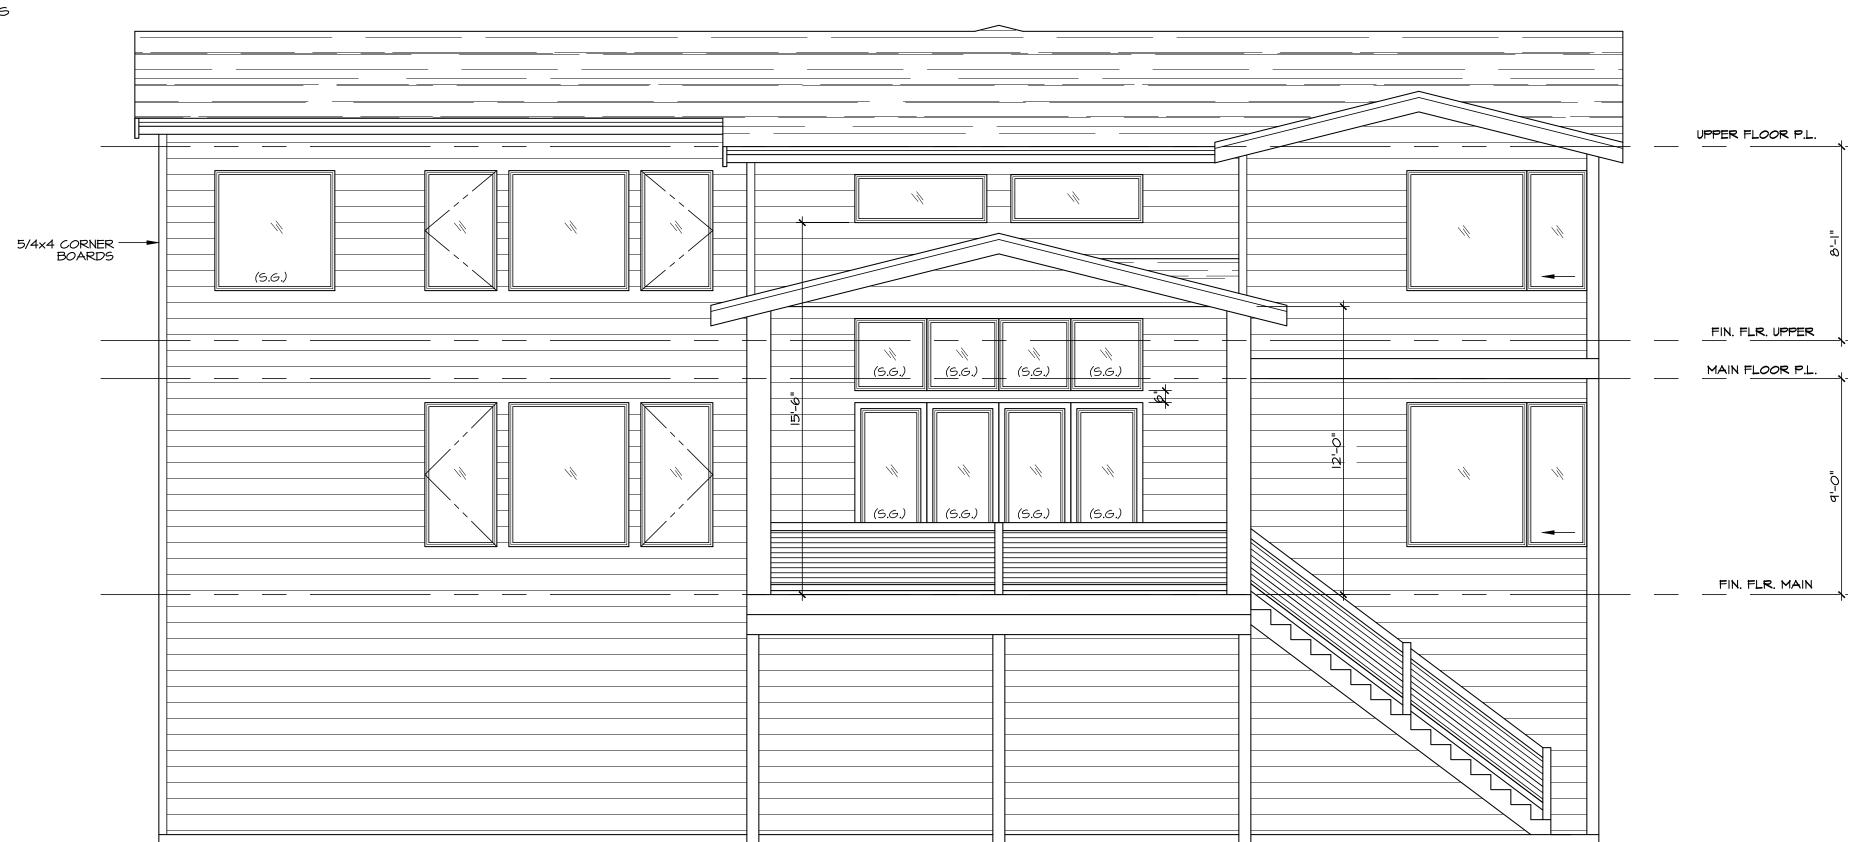

SQUARE FOOTAGE'S:

MAIN FLOOR UPPER FLOOR	1941 S.F. 1969 S.F.
TOTAL	3910 S.F.
GARAGE	761 S.F.
CVRD. PORCH	52 S.F.
CVRD. DECK	267 S.F.

ADDRESS NOTE

ADDRESS NOTE:

ADDRESS NUMBERS SHALL BE
A MINIMUM 4" HIGH WITH A
MINIMUM STROKE WIDTH OF 1/2"
AND TO BE ON A CONTRASTING
BACKGROUND PER IRC 319.1

REGISTERED ARCHITECT

MICHAEL WAYNE JOHNSON STATE OF WASHINGTON

NASH & ASSOCIATES

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3118th AVENUE NE. KIRKLAND, WA. 98033. 425-828-417

PHILIPS RIDGE PLAN 3410

date: 7-26-23 permit: revisions:

drawn by: LMD checked by: MMJ

SHEET


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REAR ELEVATION

SEE GENERAL NOTES

SCALE: 1/4" = 1'-0"





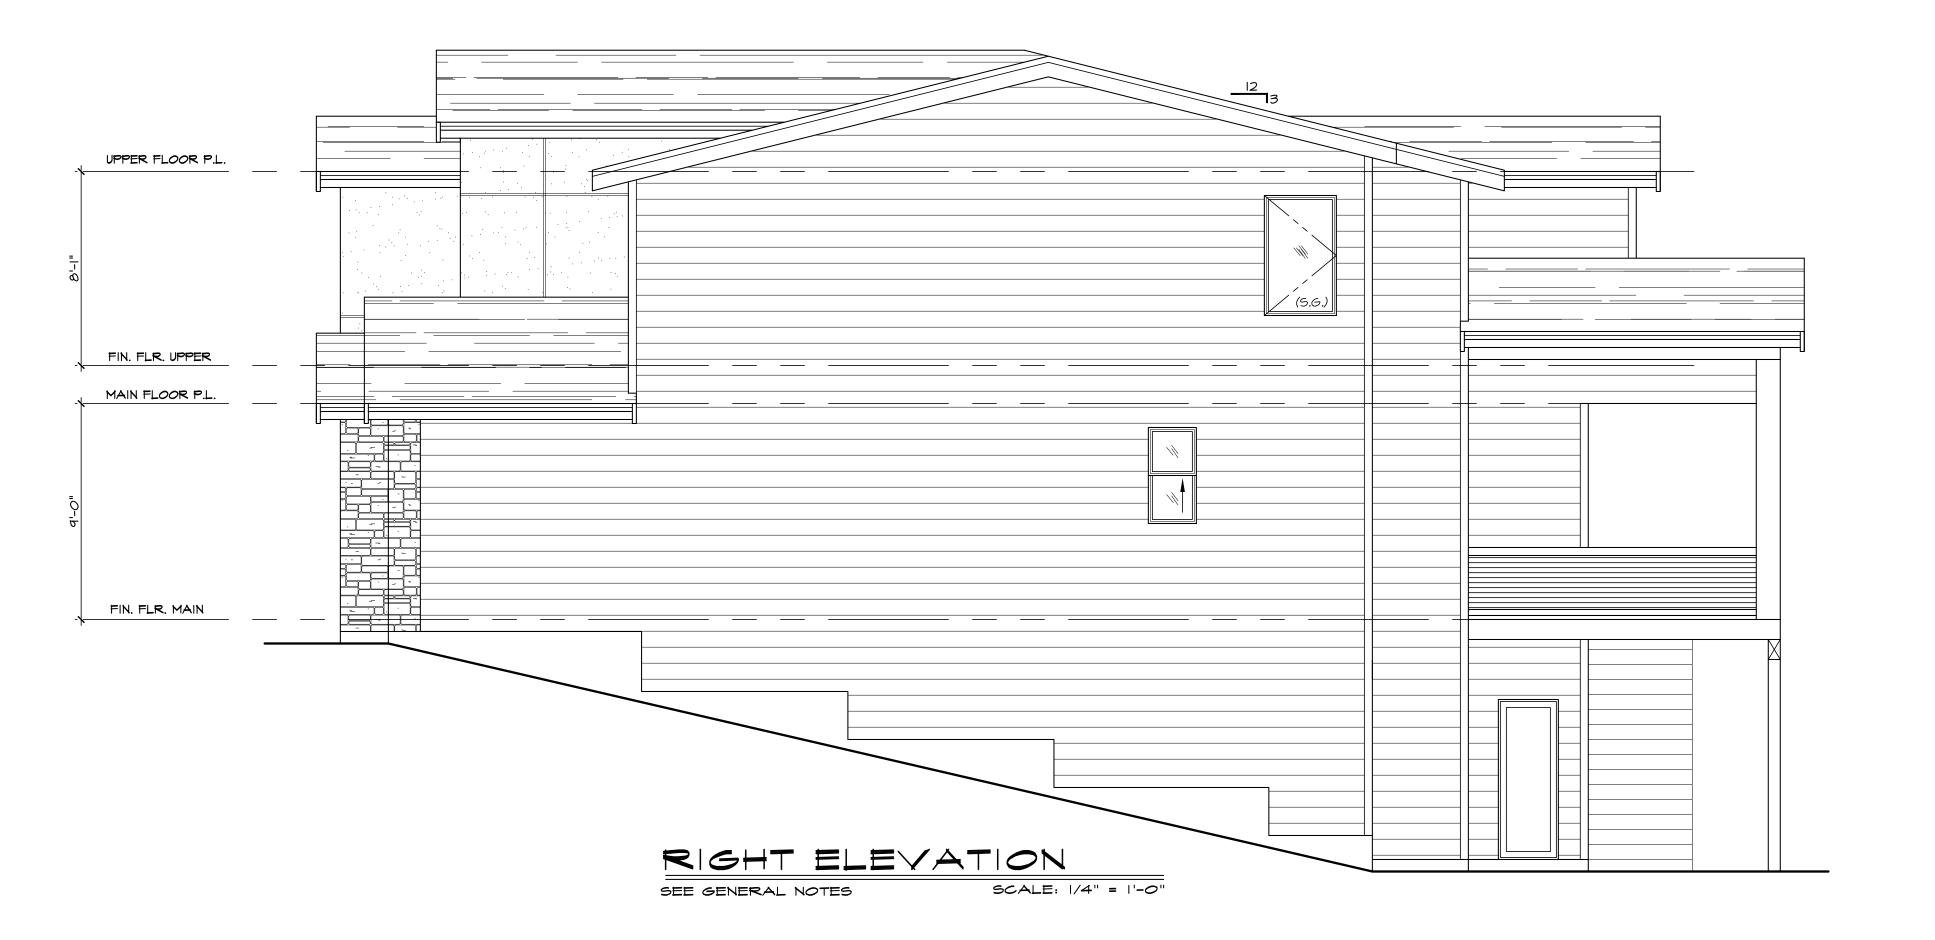

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ARCHITECTS


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SHEAR NOTE:

I. 3X MATERIAL CAN BE USED FOR I. 3X MATERIAL CAN BE USED FOR ALL MUDSILLS
2. SET A DOUBLE 2X STUD BEHIND
EVERY STHDIA HOLDOWN CALLED OUT
ON THE FOUNDATION PLAN. SET HOLDOWN
I/2" MINIMUM AWAY FROM WALL CORNERS,
WINDOW AND DOOR HEADERS. IT IS IMPORTANT
THAT THE FOUNDATION CONTRACTOR HAS THE
MAIN FLOOR PLAN SHEET TO PROPERLY
I AYOUT HOLDOWNS. LAYOUT HOLDOWNS.

3. A MST48 STRAP WITH (2) 1/2" BOLTS INTO THE FOUNDATION IS A PROPER FIX FOR A MISPLACED STHD14 HOLDOWN.

ALL WOOD IN CONTACT WITH CONCRETE SHALL BE PRESSURE TREATED OR CEDAR. PROVIDE CRAWL DRAIN @ LOW POINT IN CRAWLSPACE.

SOLID BLOCKING UNDER ALL BEARING WALLS. SLOPE ALL CONC. STOOPS AND/OR PATIOS 1/4" PER FOOT AWAY FROM DOORWAYS.

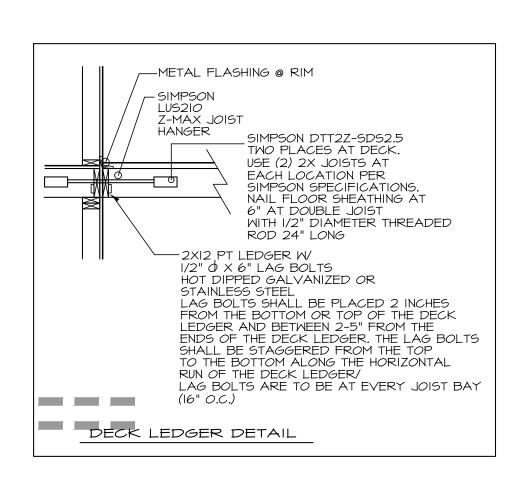BEARING WALL ABOVE


FOUNDATION VENT CALCULATION

1941 SQUARE FEET = 6.47

(12) VENTS REQUIRED

*** SHEAR NOTE: SEE SHEET LI FOR SHEAR WALL NAILING SCHEDULE, & DETAILS.

HOLDDOWN SCHEDULE					
MARK	HOLDOWN/ STRAP	ANCHOR REQUIRED			
T-I	STHD14/14 RJ	24-16d SINKERS	(2) 2X4/2X6 STUDS HF/SPF		
T-2	MST48	(34)-16d	(2) 2X4/2X6 STUDS HF/SPF		
T-3	MSTC48B3	(38)-10d	(2) 2X4/2X6 STUDS HF/SPF		
T-4	MSTC66B3Z	(38)-10d	(2) 2X4/2X6 STUDS HF/SPF		
T-5	нртв	(3)- 3/4"	3-1/2" MIN. DF/SP	SSTB28 (7/8") MIN. 24-7/8" EMBEDMENT	

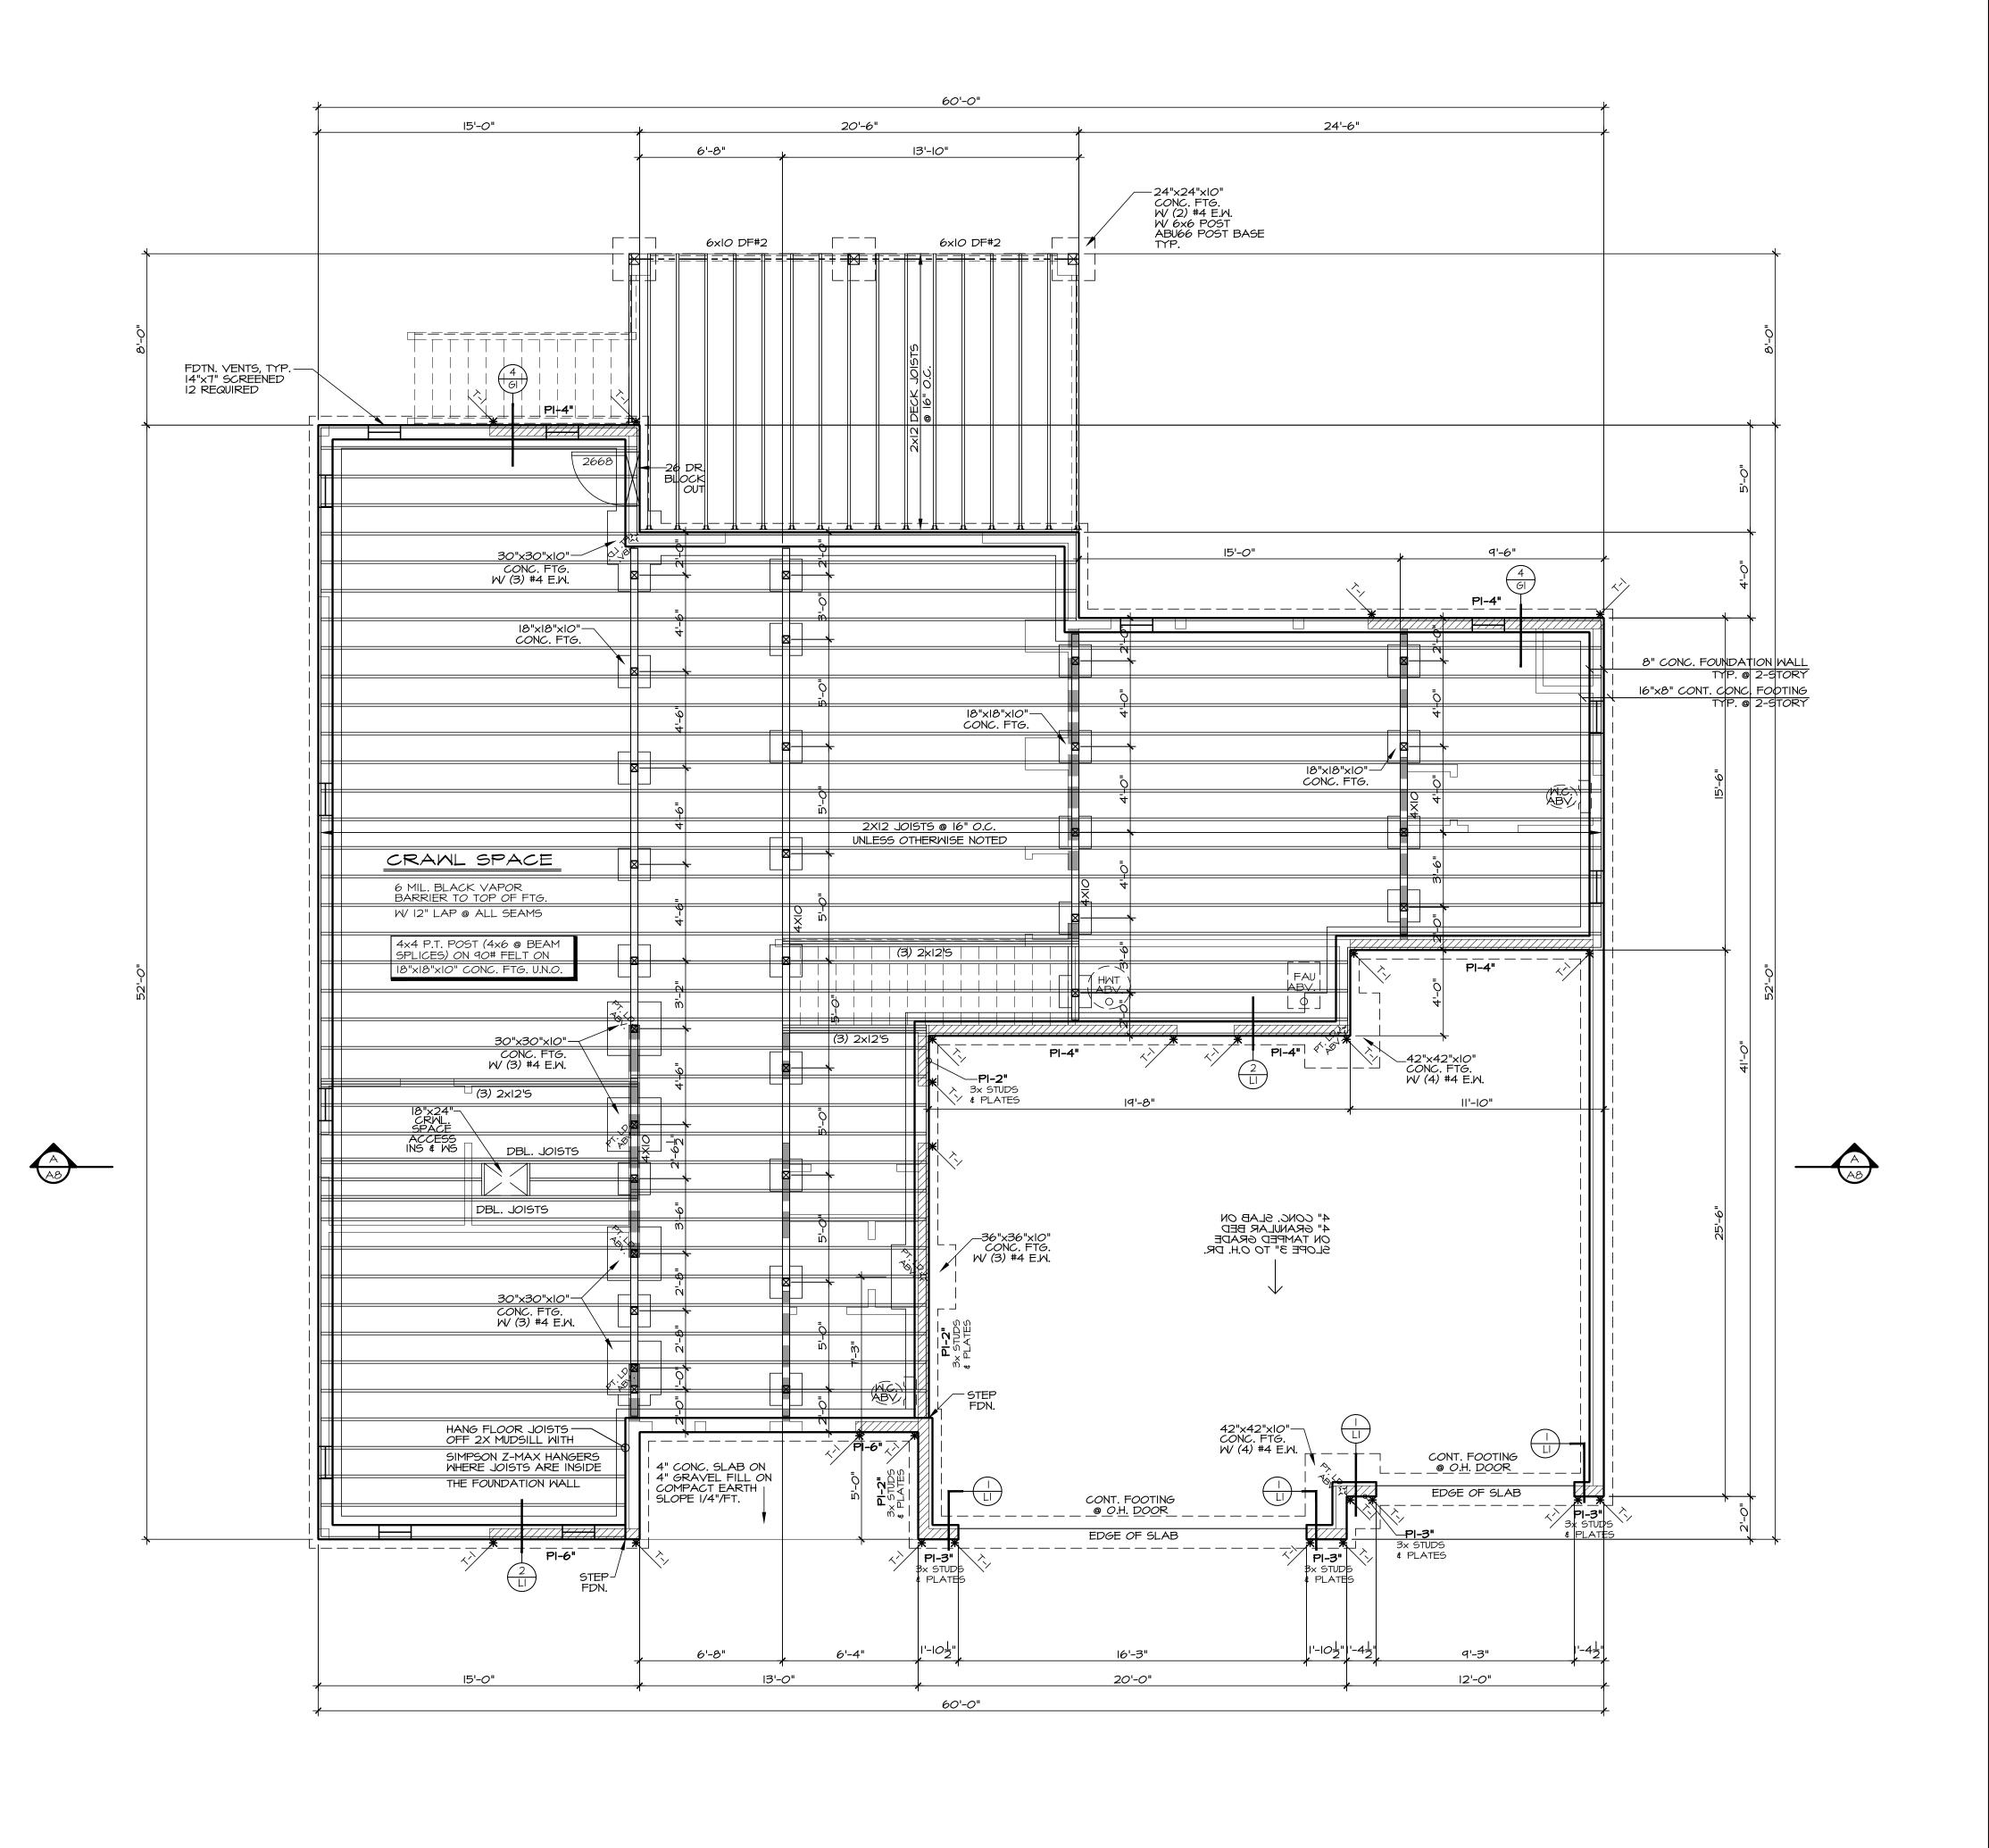

REGISTERE STATE OF MASHINGTON

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7-26-23 date: permit: revisions:

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FOUNDATION PLAN

SEE GENERAL NOTES

SCALE: 1/4" = 1'-0"

NOTES

ALL EXTERIOR WARM WALLS TO BE 2 X 6 STUDS @ 16" O.C. TYPICAL.

ALL INTERIOR WALLS TO BE 2 X 4 STUDS @ 24" O.C. TYPICAL.

ALL HEADERS TO BE 4XIO DF#2

UNLESS NOTED OTHERWISE.

FUR-OUT HEADERS TO MATCH 2 X 6

SOLID BLOCKING UNDER ALL BEARING

TUB/SHOWER UNITS SHALL HAVE FIRE BLOCKING BETWEEN WALL STUDS AND WATERPROOF SURROUNDS TO +72" FROM DRAIN. GLAZING, INCLUDING WINDOWS WITHIN +72" OF DRAIN, SHALL BE SAFTEY GLASS. SHOWER FLOW IS LIMITED TO 1.75 GAL/MIN.

EXHAUST FANS LARGER THAN 50CFM MAY BE CONNECTED TO 4" SMOOTH WALL VENT PIPE IF RUNS DO NOT EXCEED 20' IN LENGTH. THE MINIMUM SIZE OF FLEX DUCT IS 5" DIAMETER WITH A MAXIMUM RUN OF IS' COMBUSTION AIR REQUIRED FOR ALL FUEL BURNING APPLIANCES

LEGEND:

BEARING WALL

BEARING ABOVE

FLOOR LINE ABOVE

PT. LD.
ABV.

MULTIPLE 2x STUDS
POINT LOAD

SMOKE DETECTOR
IIOV INTERCONNECTED
W/ BATTERY BACK-UP.
PER IRC 314

CARBON MONOXIDE DETECTOR PER IRC 315

HEAT DETECTOR

GARAGE NOTES:

GARAGE/LIVING SEPARATION, USE 5/8" TYPE 'X' GMB AT CEILING/MALL. WRAP POSTS AND BEAMS.
 INSULATE ALL WARM WALLS AND CEILING.

FIREPLACE NOTE:

O' CLEARANCE FIREPLACE WORKERT VENT

FACTORY BUILT FIREPLACE SHALL BE INSTALLED PER MANUFACTURER'S SPECIFICATIONS AND SHALL HAVE APPROVAL LABEL ATTACHED


5/8" TYPE "X" GWB TO ROOF SHEATHING


FIREPLACES & STOVES MUST BE D.O.E. APPROVED & BE TESTED, CERTIFIED & LABELED AS SUITABLE FOR USE DURING A FIRST STAGE BURN BAN.

*** SHEAR NOTE:

SEE SHEET LI FOR SHEAR WALL NAILING SCHEDULE, & DETAILS.

HOLDDOWN SCHEDULE						
MARK HOLDOWN/ STRAP			FASTENERS	MOOD MEMBER THICKNESS/SPECIES	REQUIRED	
	T-I	STHDI4/I4 RJ	24-16d SINKERS	(2) 2X4/2X6 STUDS HF/SPF		
	T-2 MST48 T-3 MSTC48B3 T-4 MSTC66B3Z		(34)-16d	(2) 2X4/2X6 STUDS HF/SPF		
			(38)-10d	(2) 2X4/2X6 STUDS HF/SPF		
			(38)-10d	(2) 2X4/2X6 STUDS HF/SPF		
	T-5	нртв	(3)- 3/4"	3-1/2" MIN. DF/SP	SSTB28 (7/8") MIN. 24-7/8" EMBEDMENT	

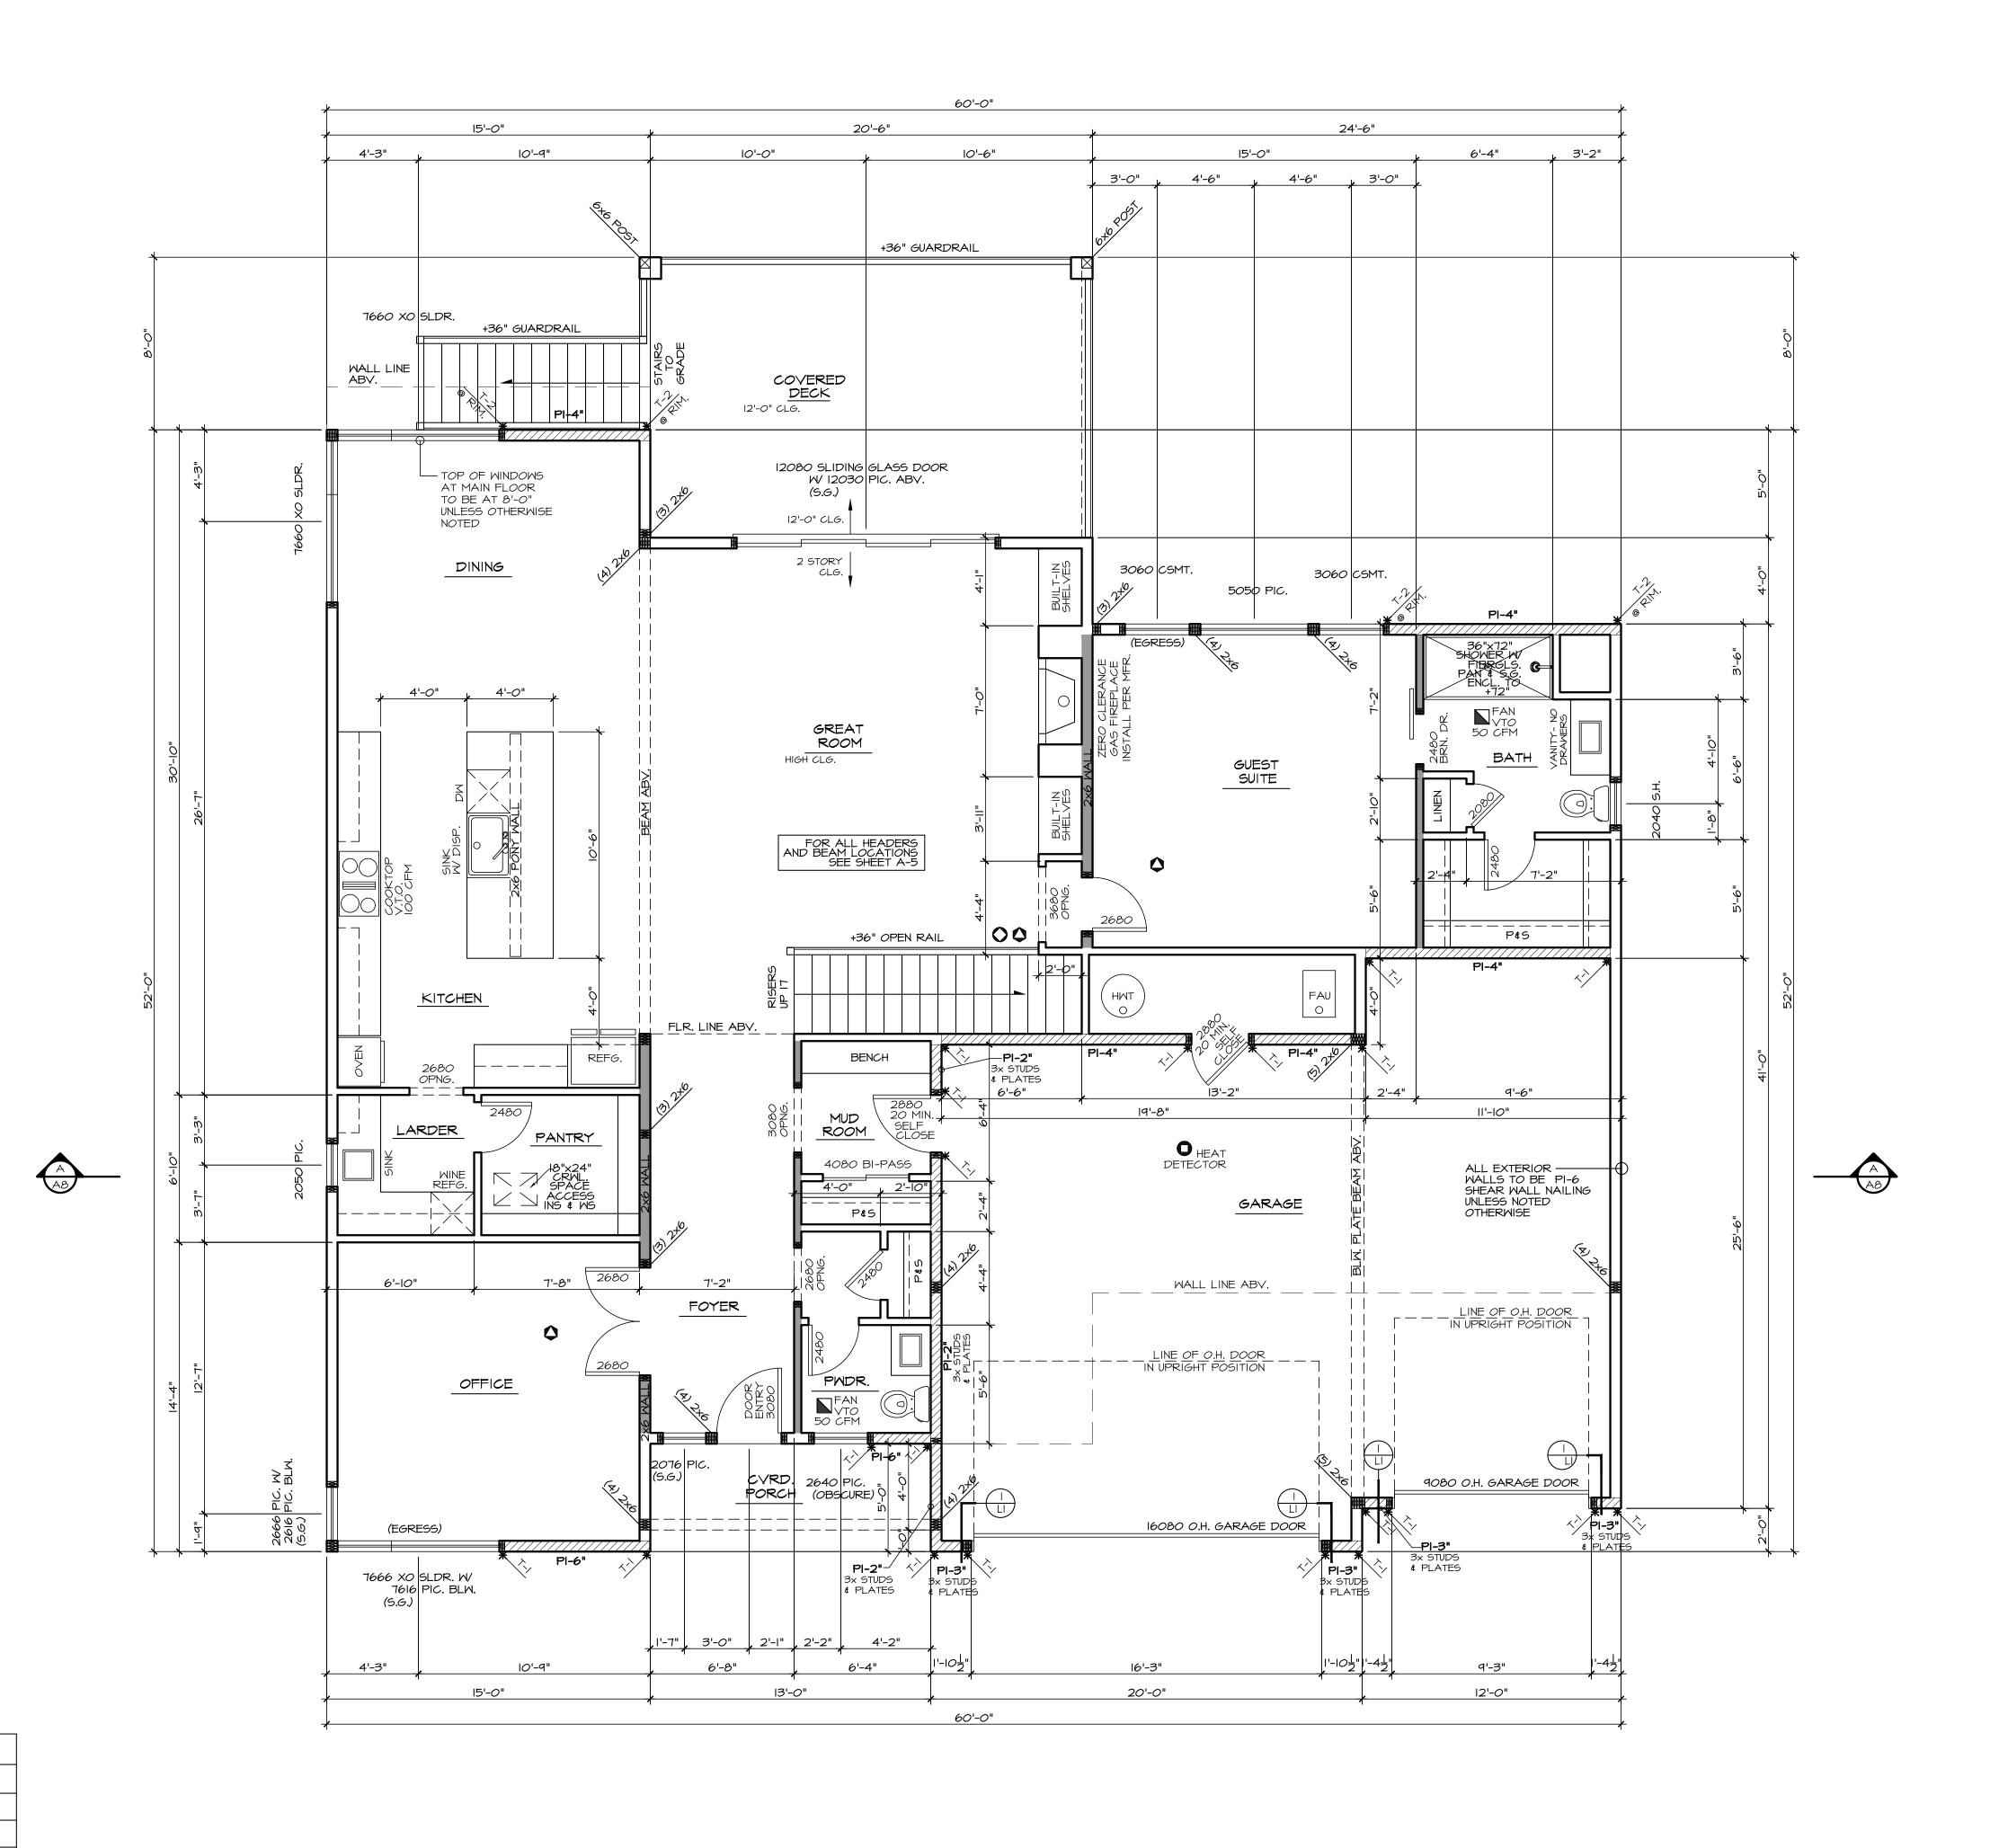

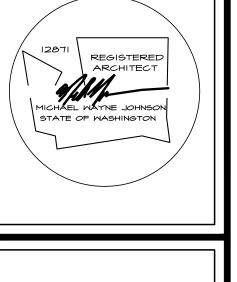

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PHILIPS RIDGE PLAN 3410

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date: 7-26-23 permit: revisions:

drawn by: LMD checked by: MWJ

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MAIN FLOOR PLAN

SEE GENERAL NOTES SCALE: 1/4" = 1'-0"

NOTES

ALL EXTERIOR WARM WALLS TO BE 2 X 6 STUDS @ 16" O.C. TYPICAL.

ALL INTERIOR WALLS TO BE 2 X 4 STUDS @ 24" O.C. TYPICAL.

ALL HEADERS TO BE 4XIO DF#2 UNLESS NOTED OTHERWISE. FUR-OUT HEADERS TO MATCH 2 X 6

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TUB/SHOWER UNITS SHALL HAVE FIRE BLOCKING BETWEEN WALL STUDS AND WATERPROOF SURROUNDS TO +72" FROM DRAIN. GLAZING, INCLUDING WINDOWS WITHIN +72" OF DRAIN, SHALL BE SAFTEY GLASS. SHOWER FLOW IS LIMITED TO 1.75 GAL/MIN.

EXHAUST FANS LARGER THAN 50CFM MAY BE CONNECTED TO 4" SMOOTH WALL VENT PIPE IF RUNS DO NOT EXCEED 20' IN LENGTH.
THE MINIMUM SIZE OF FLEX DUCT 15 5"
DIAMETER WITH A MAXIMUM RUN OF 15'

COMPLICTION AIR REQUIRED FOR ALL FUEL BURNING APPLIANCES

LEGEND:

	BEARING WALL
100,300,300	BEARING ABOVE
	FLOOR LINE ABOV
PT. LD. ABV. 💢	POINT LOAD ABOV
ш им	MULTIPLE 2x STUDS @ POINT LOAD

SMOKE DETECTOR
IIOV INTERCONNECTED
W/ BATTERY BACK-UP.
PER IRC 314

CARBON MONOXIDE DETECTOR PER IRC 315

GARAGE NOTES:

 GARAGE/LIVING SEPARATION, USE 5/8" TYPE 'X' GMB AT CEILING/MALL. MRAP POSTS AND BEAMS.
 INSULATE ALL WARM WALLS AND CEILING.

FIREPLACE NOTE:

O' CLEARANCE FIREPLACE W/
DIRECT VENT

FACTORY BUILT FIREPLACE SHALL
BE INSTALLED PER MANUFACTURER'S
SPECIFICATIONS AND SHALL HAVE
APPROVAL LABEL ATTACHED


5/8" TYPE "X" GWB TO ROOF SHEATHING

FIREPLACES & STOVES MUST BE D.O.E. APPROVED & BE TESTED, CERTIFIED & LABELED AS SUITABLE FOR USE DURING A FIRST STAGE BURN BAN.

*** SHEAR NOTE:

SEE SHEET LI FOR SHEAR WALL NAILING SCHEDULE, & DETAILS.

HOLDDOWN SCHEDULE						
MARK	HOLDOWN/ STRAP	FASTENERS	WOOD MEMBER THICKNESS/SPECIES	REQUIRED		
T-I	STHD14/14 RJ	24-16d SINKERS	(2) 2X4/2X6 STUDS HF/SPF			
T-2	MST48	(34)-16d	(2) 2X4/2X6 STUDS HF/SPF			
T-3	MSTC48B3	(38)-10d	(2) 2X4/2X6 STUDS HF/SPF			
T-4	MSTC66B3Z	(38)-10d	(2) 2X4/2X6 STUDS HF/SPF			
T-5	НD7В	(3)- 3/4"	3-1/2" MIN. DF/SP	SSTB28 (7/8") MIN. 24-7/8" EMBEDMENT		

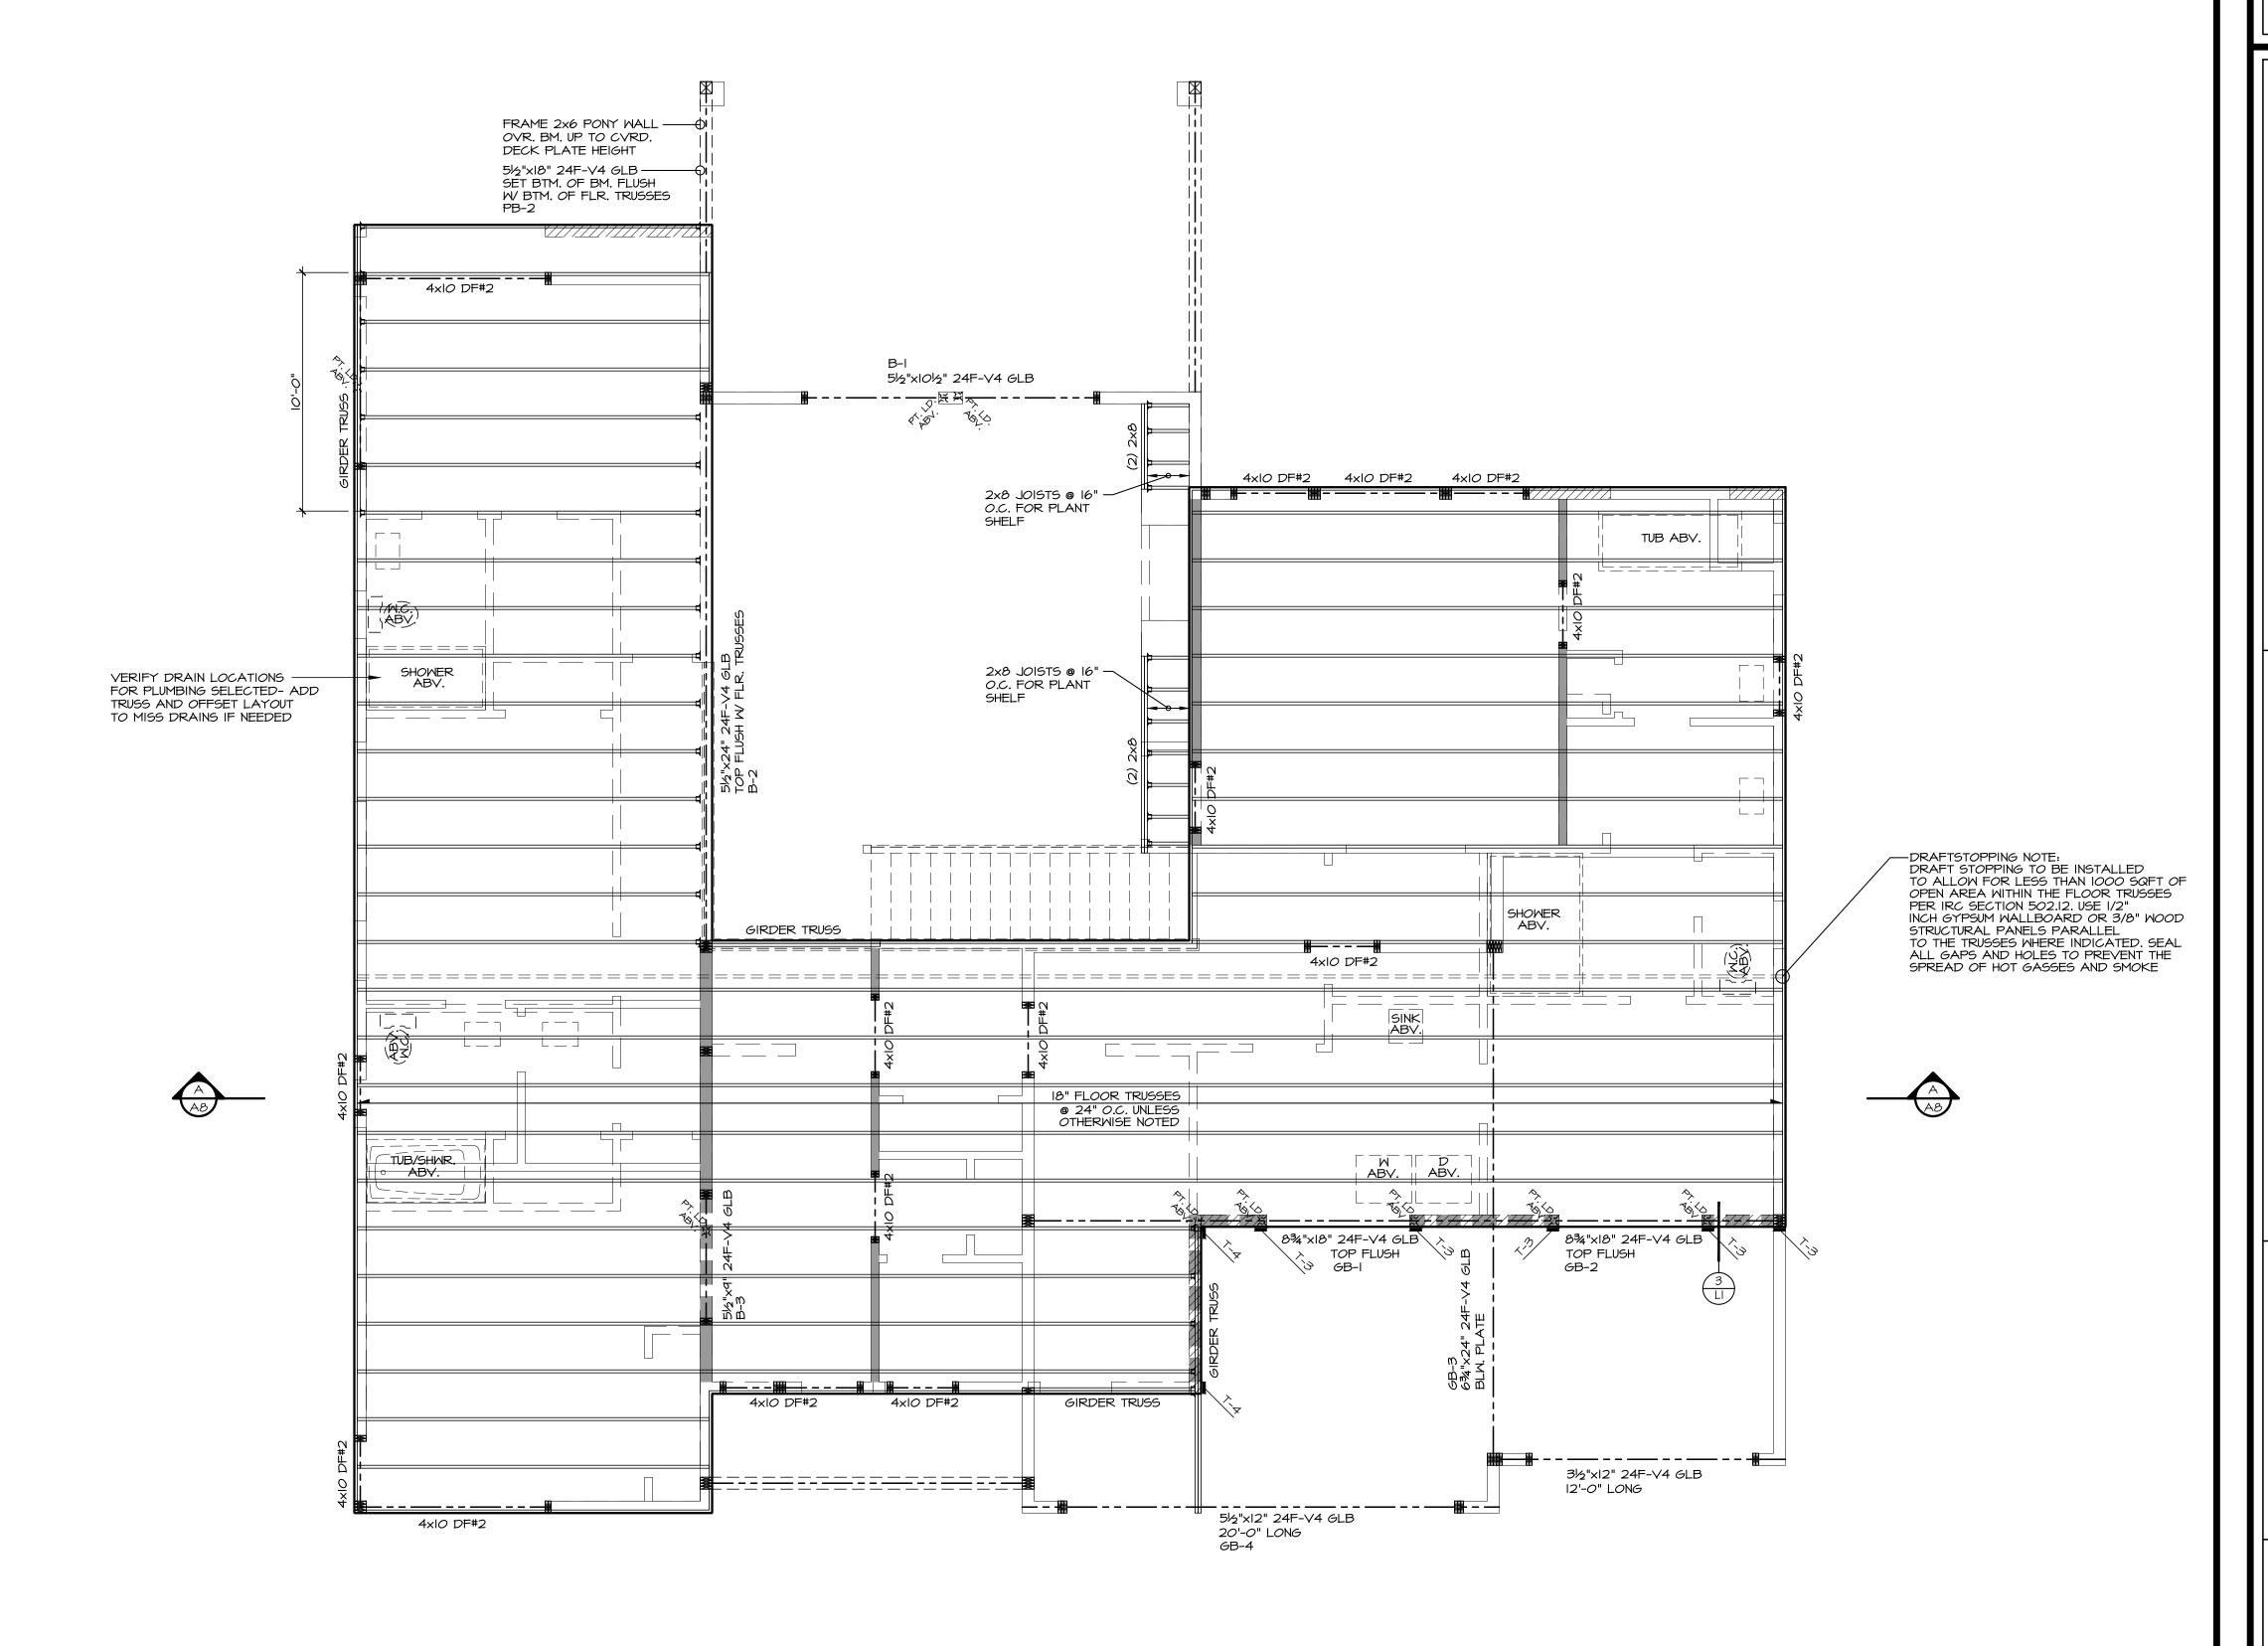

REGISTERED ARCHITECT

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www.nash-architects.com

date: 7-26-23 permit: revisions:

drawn by: LMD checked by: MMJ

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UPPER FLOOR FRAMING PLAN
SEE GENERAL NOTES SCALE:

SCALE: 1/4" = 1'-0"

NOTES:

ALL EXTERIOR WARM WALLS TO BE 2 X 6 STUDS @ 16" O.C. TYPICAL.

ALL INTERIOR WALLS TO BE 2 X 4 STUDS @ 24" O.C. TYPICAL.

ALL HEADERS TO BE 4XIO DF#2 UNLESS NOTED OTHERWISE. FUR-OUT HEADERS TO MATCH 2 X 6

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THE MINIMUM SIZE OF FLEX DUCT IS 5"
DIAMETER WITH A MAXIMUM RUN OF IS'

COMBUSTION AIR REQUIRED FOR ALL FUEL BURNING APPLIANCES

LEGEND:

BEARING WALL

BEARING ABOVE

FLOOR LINE ABOVE

PT. LD.
ABV.
M WILLIPLE 2x STUDS
POINT LOAD
POINT LOAD

SMOKE DETECTOR
IIOV INTERCONNECTED
W/ BATTERY BACK-UP.
PER IRC 314

CARBON MONOXIDE DETECTOR PER IRC 315

GARAGE NOTES:

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FIREPLACE NOTE:

O' CLEARANCE FIREPLACE W/
DIRECT VENT

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SPECIFICATIONS AND SHALL HAVE
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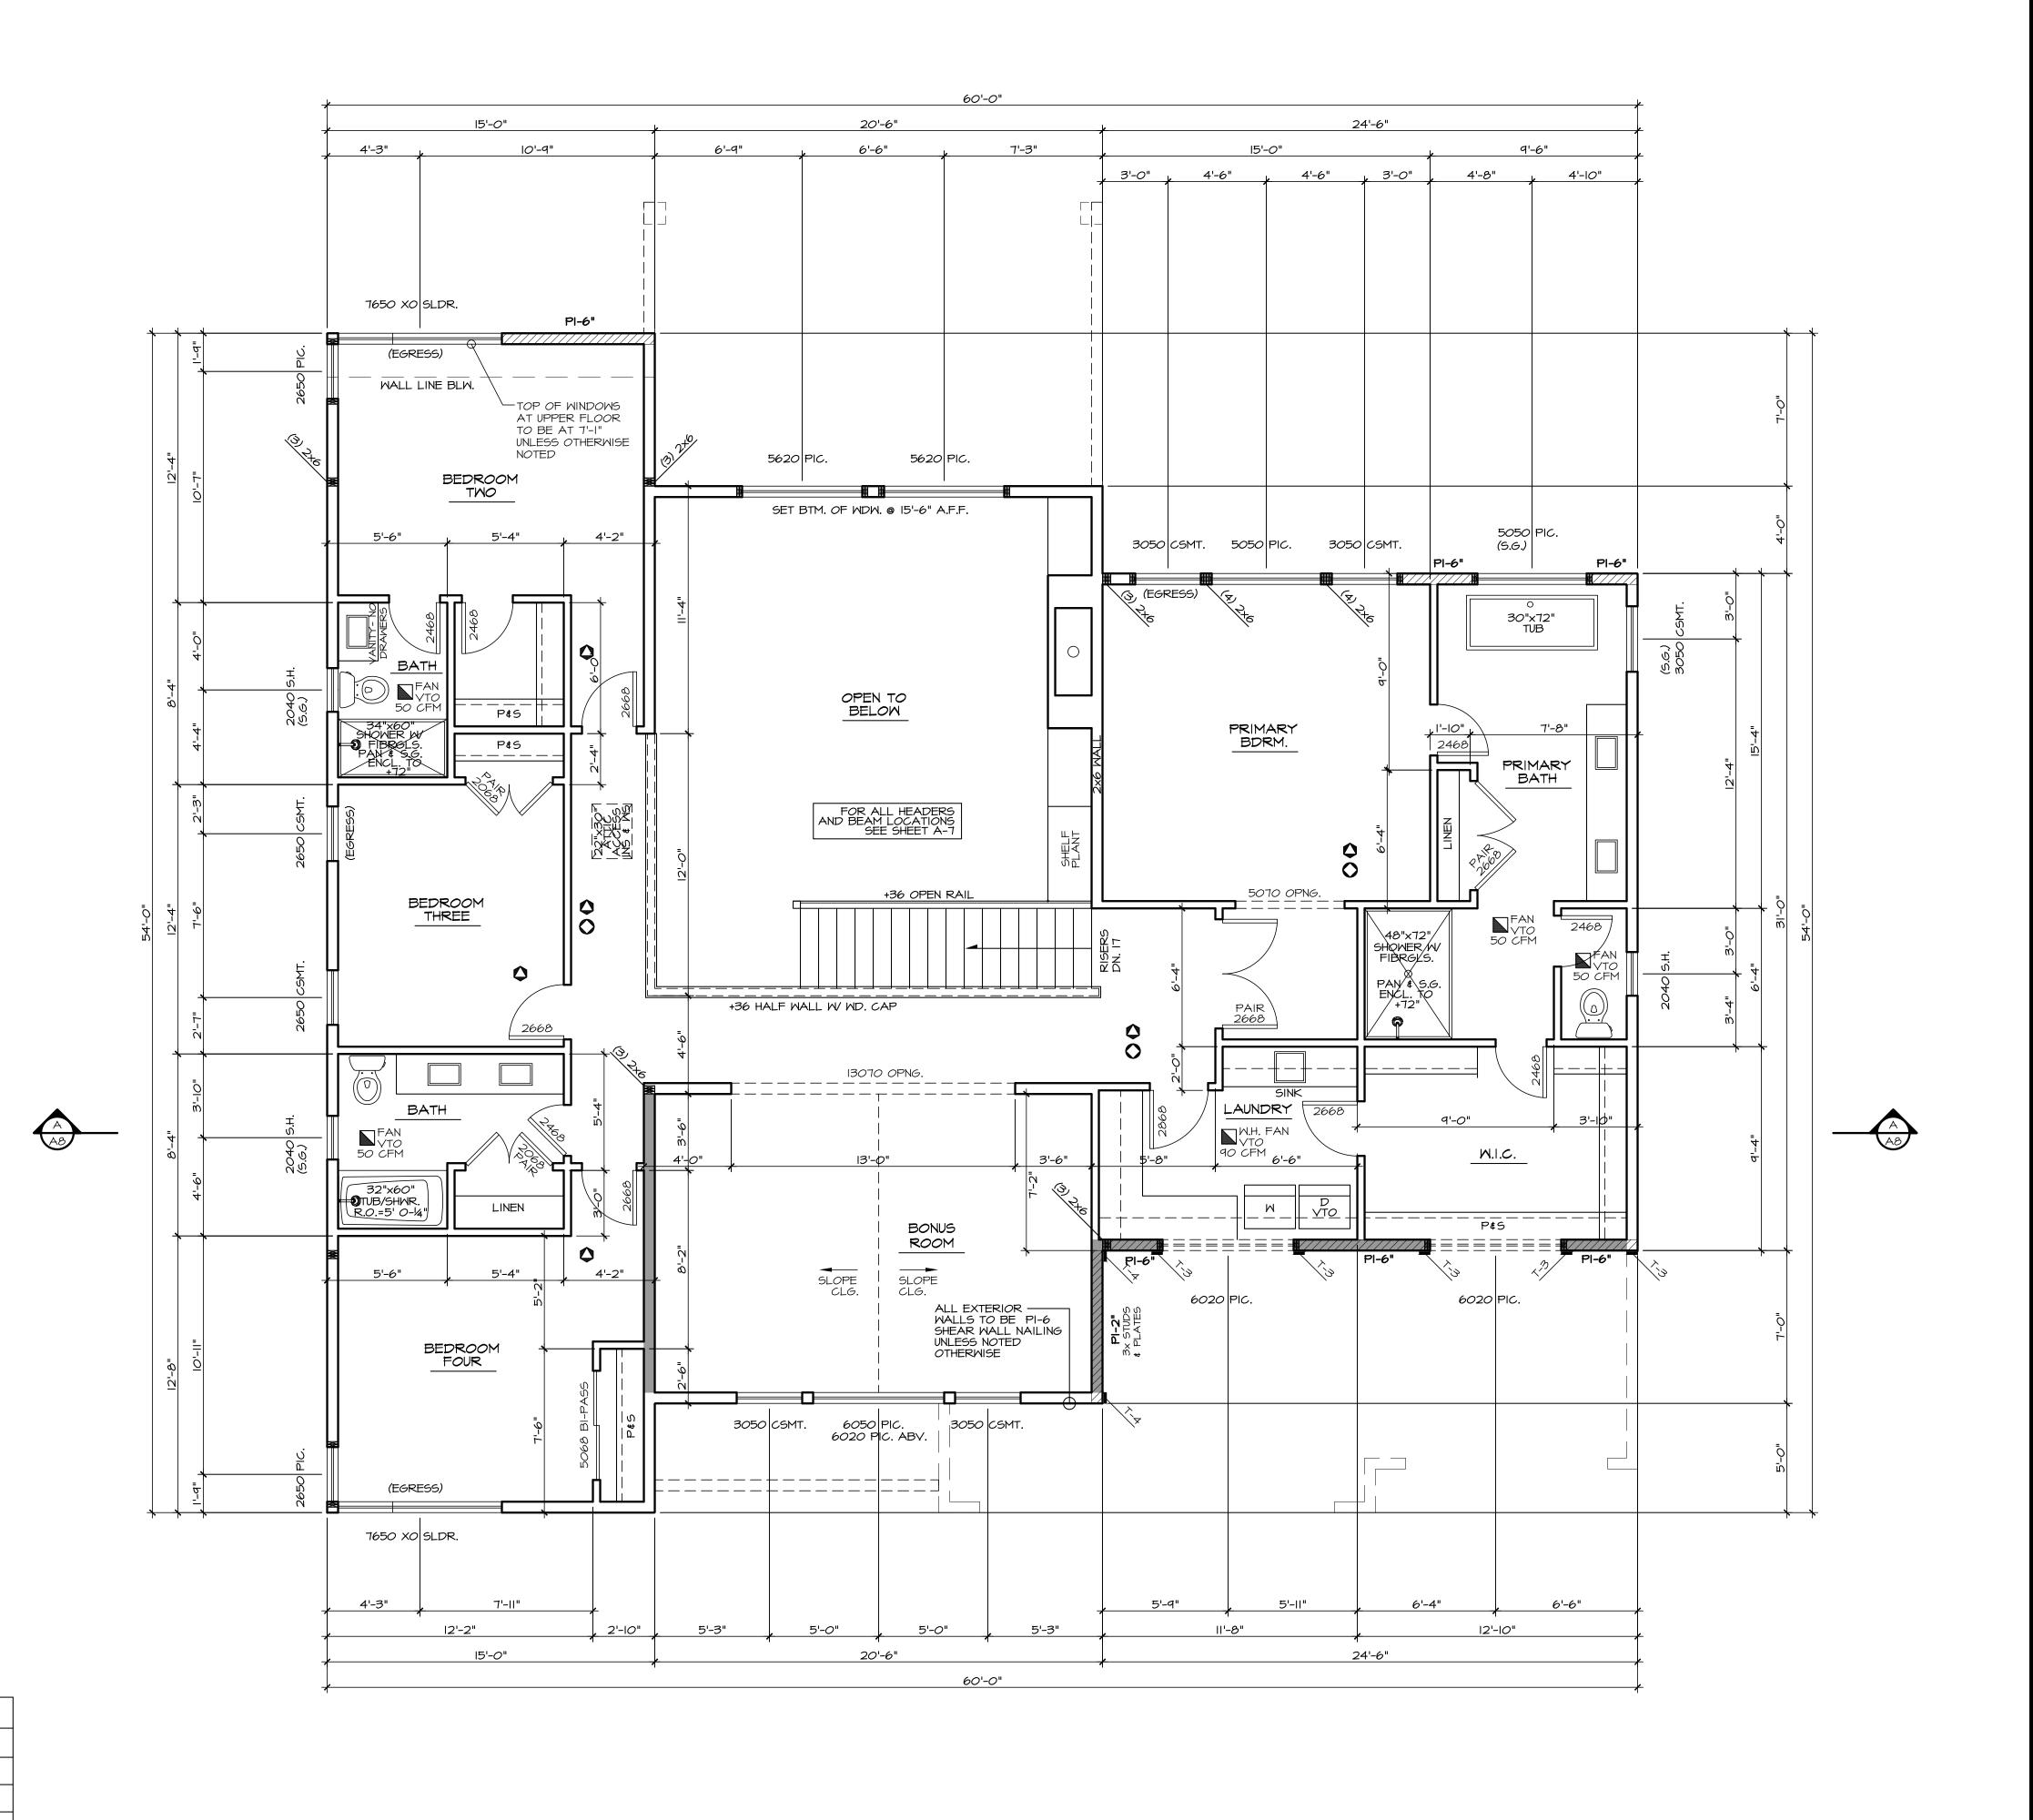
5/8" TYPE "X" GWB TO ROOF SHEATHING


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*** SHEAR NOTE:

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T-2	MST48	(34)-16d	(2) 2X4/2X6 STUDS HF/SPF			
T-3	MSTC48B3	(38)-10d	(2) 2X4/2X6 STUDS HF/SPF			
T-4	MSTC66B3Z	(38)-10d	(2) 2X4/2X6 STUDS HF/SPF			
T-5	нр7В	(3)- 3/4"	3-1/2" MIN. DF/SP	SSTB28 (7/8") MIN. 24-7/8" EMBEDMENT		





ASSOCIATES

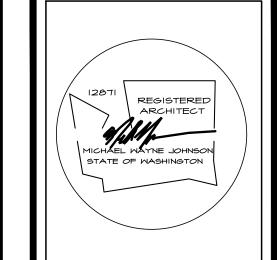ARCHITECTS

PHILIPS RIDGE PLAN 3410

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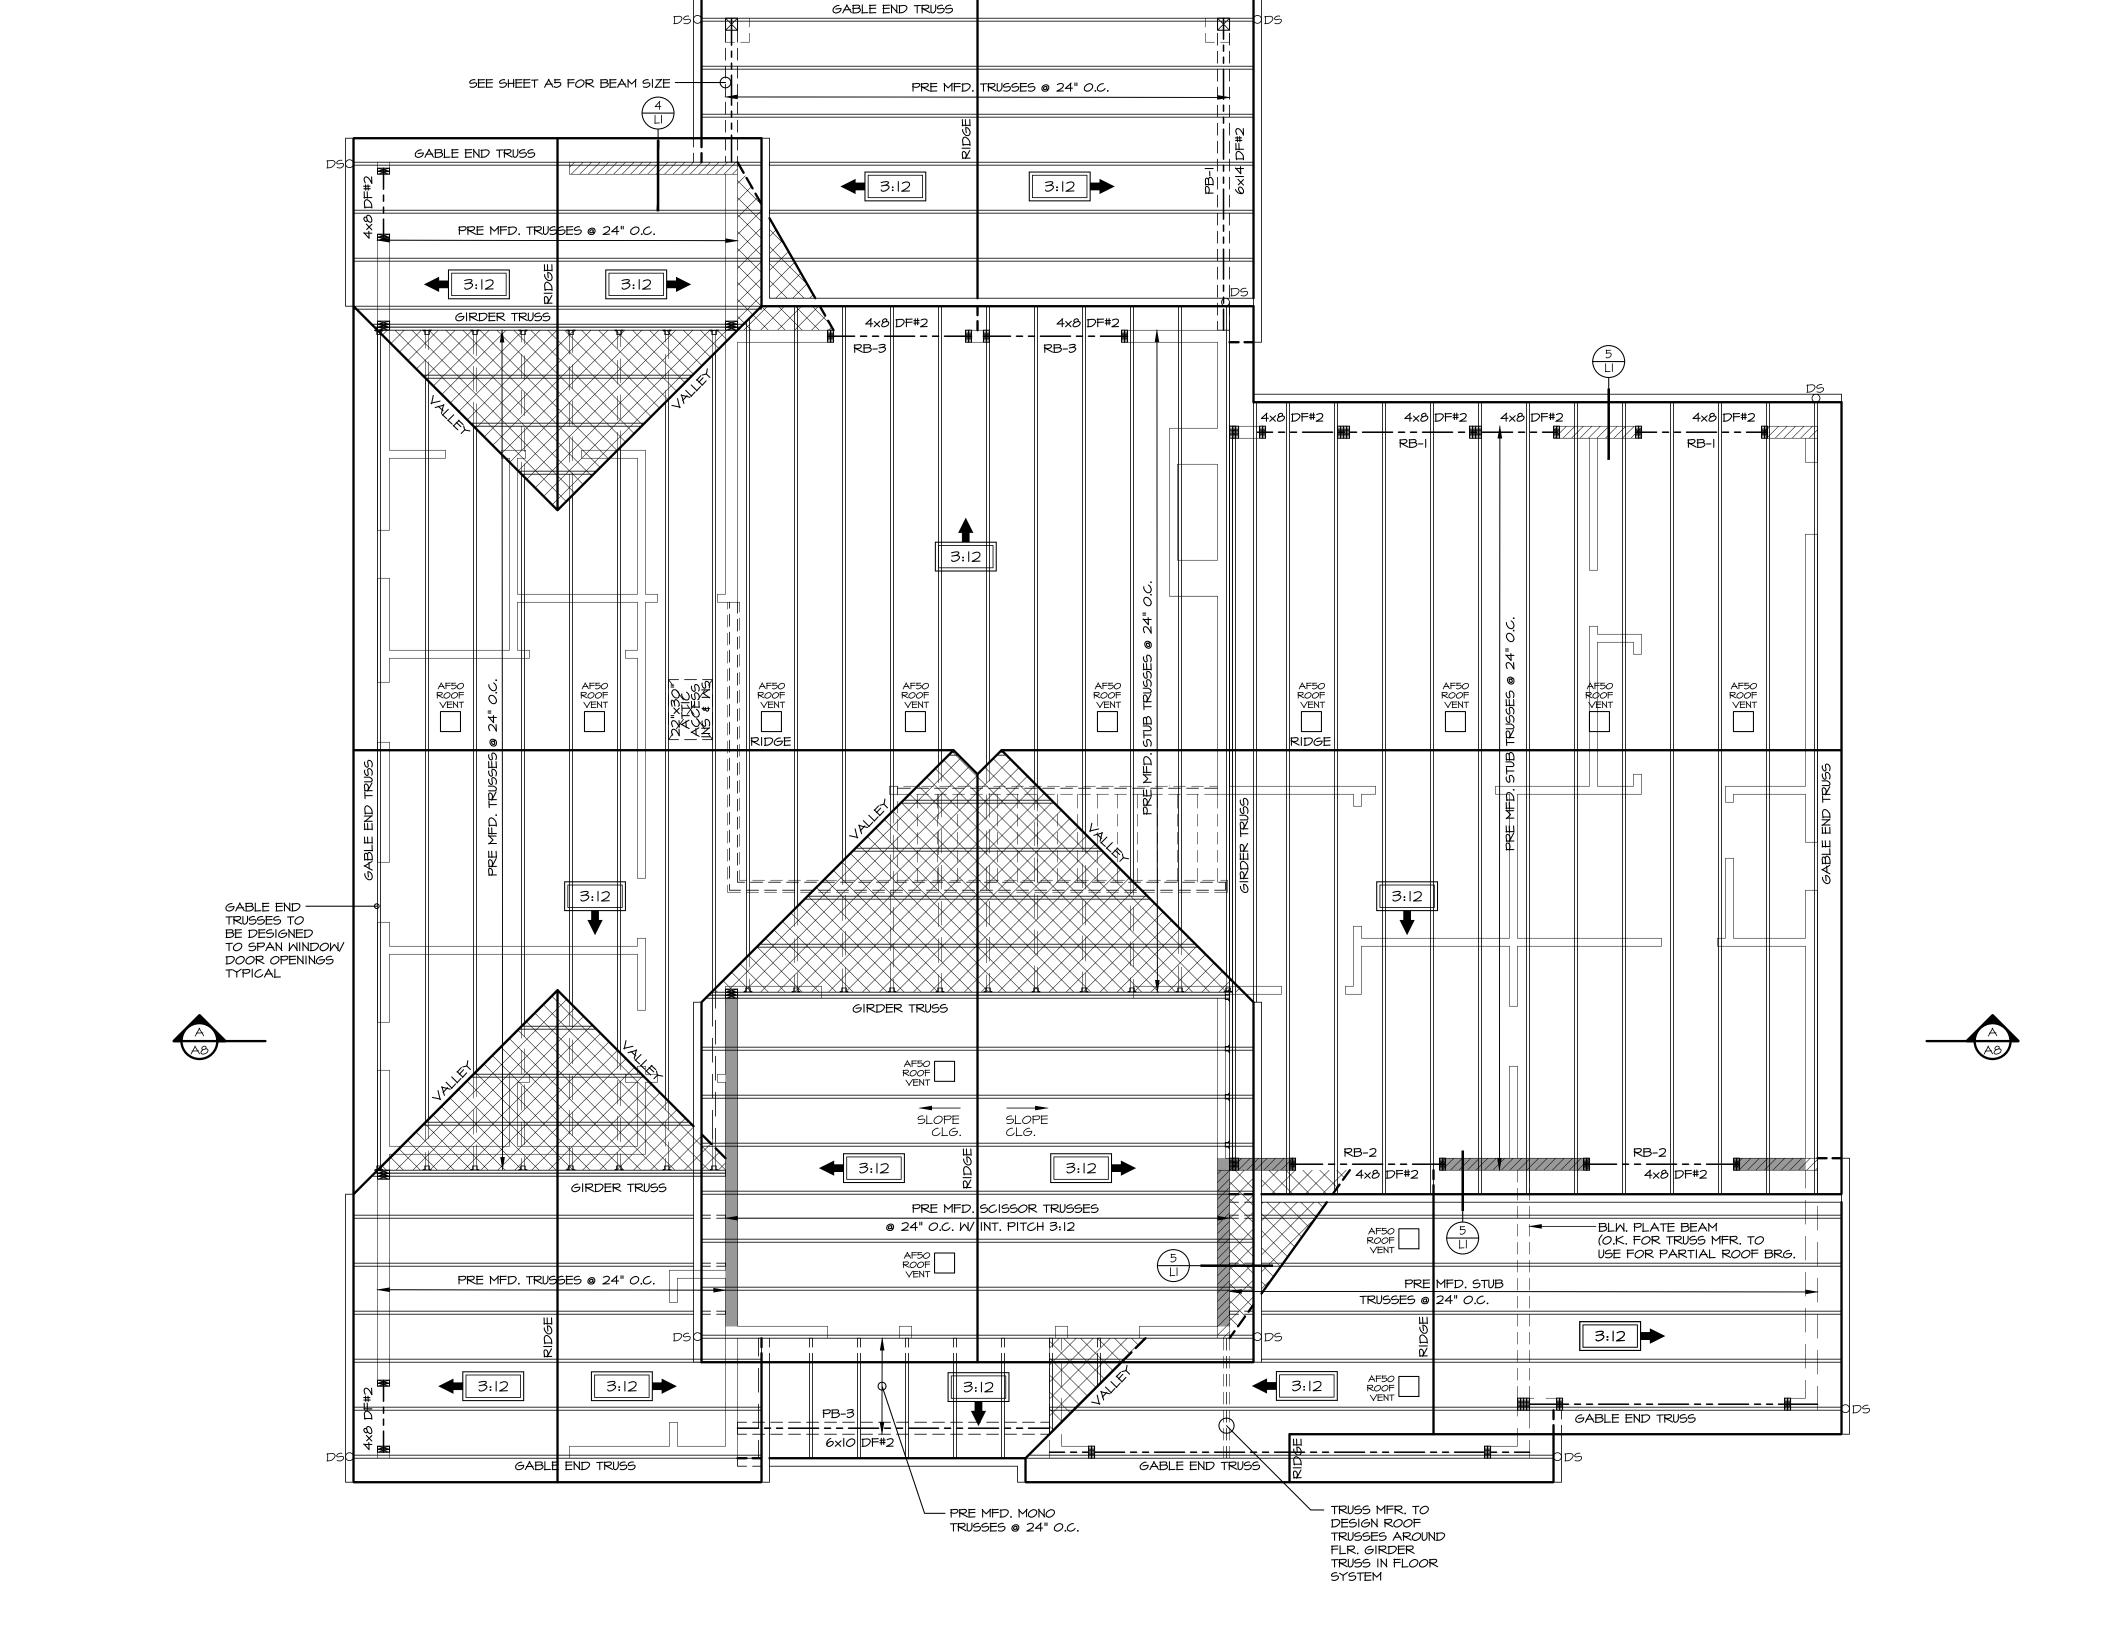
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UPPER FLOOR PLAN

SEE GENERAL NOTES SCALE: 1/4" = 1'-0"



ROOF FRAMING NOTES

CUT RAFTER TAILS TO MATCH 2x4
TRUSSES

TRUSSES

CONNECTORS SHALL BE ENGINEERED BY TRUSS MANUFACTURER

ROOF RITCH CHALL BE 3.12

ROOF PITCH SHALL BE 3:12
TYPICAL UNLESS NOTED OTHERWISE
ROOF OVERHANG SHALL BE 12" U.N.O.

BEARING BELOW

DOWNSPOUT

2x6 OVERFRAMING

TRUSS NOTE

ALL TRUSSES SHALL HAVE:

 STRESS ANALYSIS AND DRAWINGS / DETAILS STAMPED BY A STATE REGISTERED ENGINEER.
 MANUFACTURER'S STAMP ON PRE-MANUFACTURED TRUSSES.

3. BRACED TO MANUFACTURER'S SPECIFICATIONS.

4. STRESS ANALYSIS AND DETAILS SHALL BE SUBMITTED TO BUILDING DEPT. FOR APPROVAL AND SHALL BE KEPT ON SITE FOR FRAMING INSPECTION.

5. TRUSSES WILL NOT BE FIELD ALTERED WITHOUT PRIOR BUILDING DEPARTMENT APPROVAL OR ENGINEERING CALCULATIONS.

6. ALL TRUSSES SHALL HAVE SIMPSON
H-I CLIPS AT ENDS. WHERE TRUSSES
ARE PARALLEL TO WALL, USE SIMPSON
L30 AT MIDSPAN. USE SIMPSON STC
CLIPS AT NON-BEARING WALLS

ROOF VENTING CALCULATION-PER 2018 IRC R806.2

2431 SQFT AREA =8.10 SQFT REQUIRED

(8.10) X (50%)= 4.05 SQFT MIN. REQUIRED AT EAVES TYPICAL TRUSS BLOCK HAS (4) 2 Φ SCREENED HOLES PROVIDING 6.28 SQ. IN. (.044 SQFT) PER BLOCK.

APPROXIMATELY 95 VENTED BLOCKS= 4.18 SQFT PROVIDED

(8.10) X (50%)= 4.05 SQFT MIN. REQUIRED WITHIN 3' OF THE RIDGE AF50 ROOF JACK VENTS= .34 SQFT EACH VENT PROVIDE (12) AF50 VENTS= 4.08 SQFT PROVIDED

TOTAL VENT AREA PROVIDED = 8.26 SQ FT

ROOF FRAMING PLAN
SEE GENERAL NOTES SCALE: 1/4" = 1'-0"



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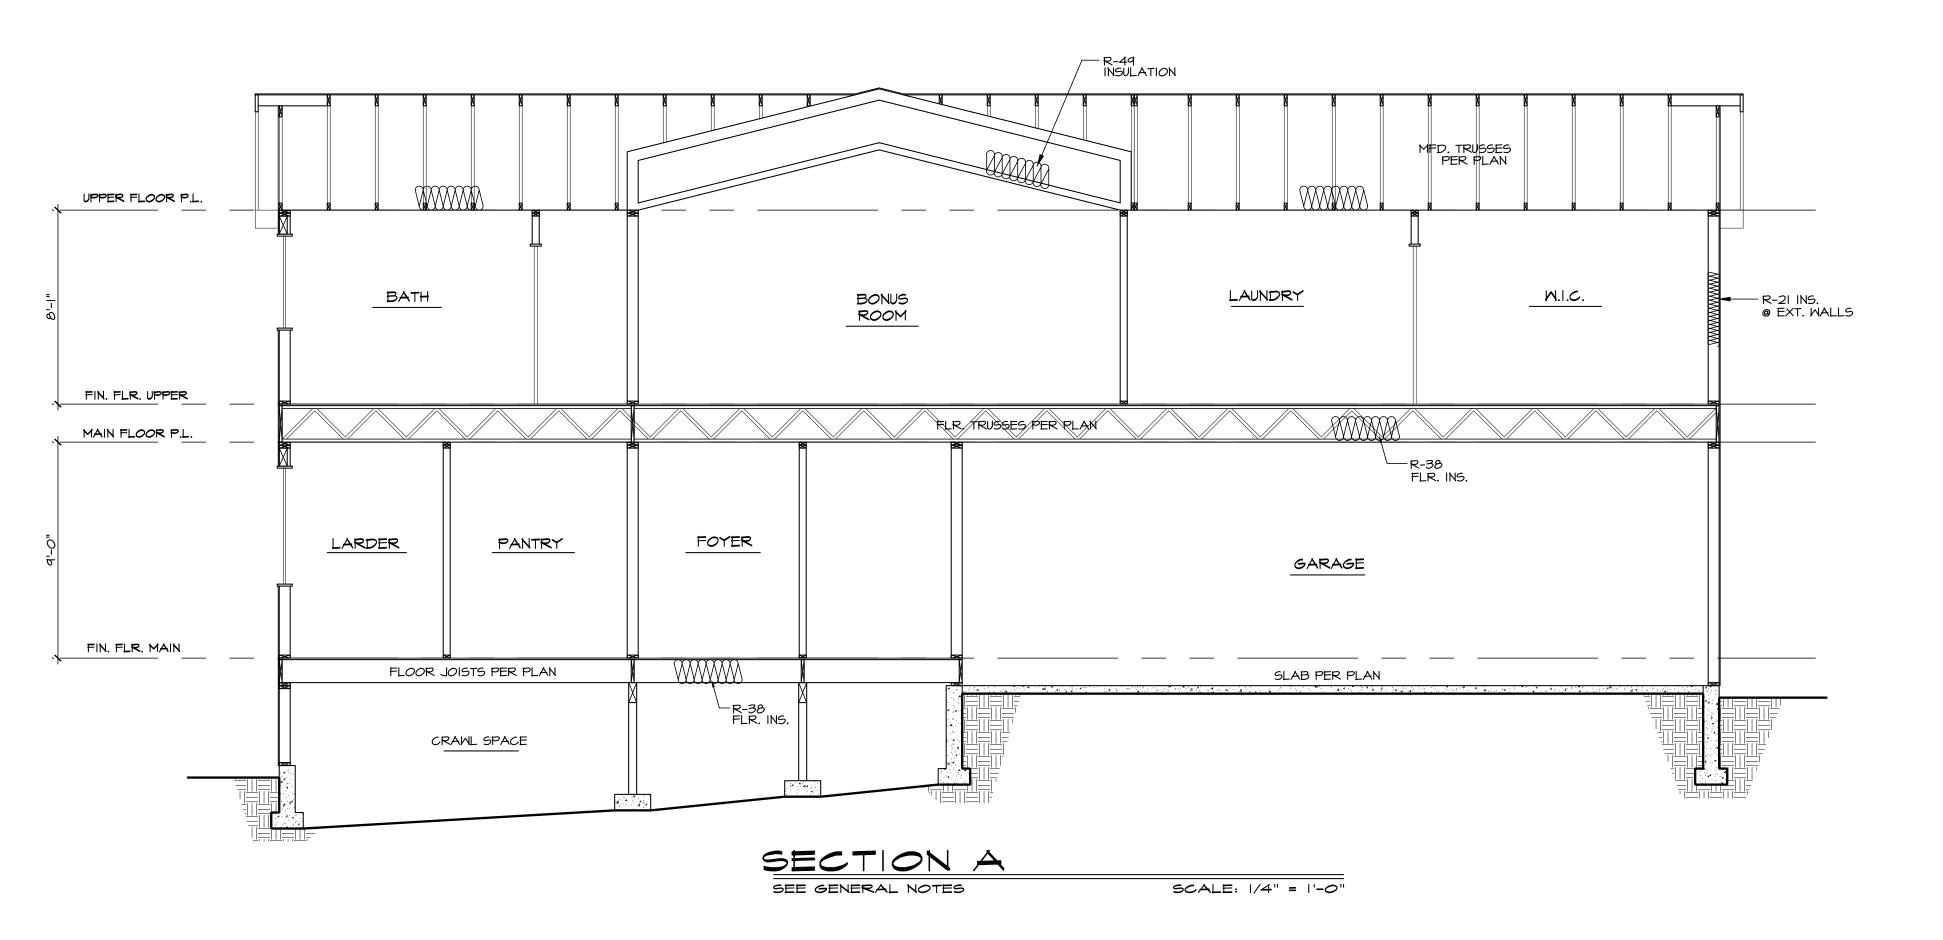
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2018 MASHINGTON STATE ENERGY CODE

CLIMATE ZONE 5 AND MARINE 4

FENESTRATION U-FACTOR	SKYLIGHT U-FACTOR	GLAZED FENESTRATION SHGC		MOOD FRAMED WALL R-VALUE	FLOOR R-VALUE	BELOW GRADE WALL R-VALUE	SLAB R-VALUE AND DEPTH
0.28	0.50	NR	R-49 (R-38 VAULTED)	R-21	R-38	10/15 R-21 +TB	R-IO, 2 FEET

*TABLE 406.3- ENERGY CREDITS (SINGLE FAMILY)

THIS PLAN REQUIRES 6 CREDITS SINCE IT IS OVER 1500 SQUARE FEET AND UNDER 5000 SQUARE FEET

OPTION		CREDIT
HEATING OPTION 2	HEAT PUMP (ELECTRIC)	1.0
ENERGY OPTION 1.3	PRESCRIPTIVE COMPLIANCE IS BASED ON TABLE R402.I.I WITH THE FOLLOWING MODIFICATIONS: VERTICAL FENESTRATION U=0.28 FLOOR R-38 SLAB ON GRADE R-IO PERIMETER AND UNDER ENTIRE SLAB BELOW GRADE R-IO PERIMETER AND UNDER ENTIRE SLAB OR COMPLIANCE BASED ON SECTION R402.I.4: REDUCE THE TOTAL CONDUCTIVE UA BY 5%	.5
ENERGY OPTION 3.5	AIR-SOURCE CENTRALLY DUCTED HEAT PUMP WITH A MINIMUM HSPF OF II.O	1.5
ENERGY OPTION 4.2	HVAC EQUIPMENT AND ASSOCIATED DUCT SYSTEM(S) INSTALLATION SHALL COMPLY WITH THE REQUIREMENTS OF SECTION R403.3.7. LOCATING SYSTEM COMPONENTS IN CONDITIONEI CRAWLSPACES IS NOT PERMITTED UNDER THIS OPTION. ELECTRIC RESISTANCE HEAT AND DUCT! HEAT PUMPS ARE NOT PERMITTED UNDER THIS OPTION. DIRECT COMBUSTION HEATING WITH AFUILESS THAN 80% IS NOT PERMITTED UNDER THIS OPTION.	_ESS
ENERGY OPTION 5.5	MATER HEATING SYSTEM SHALL INCLUDE THE FOLLOWING: ELECTRIC HEAT PUMP MATER HEATER MEETING THE STANDARDS FOR TIER III OF NEEA'S ADVANCED WATER HEATING SPECIFICATION	2.0

REGISTERED ARCHITECT

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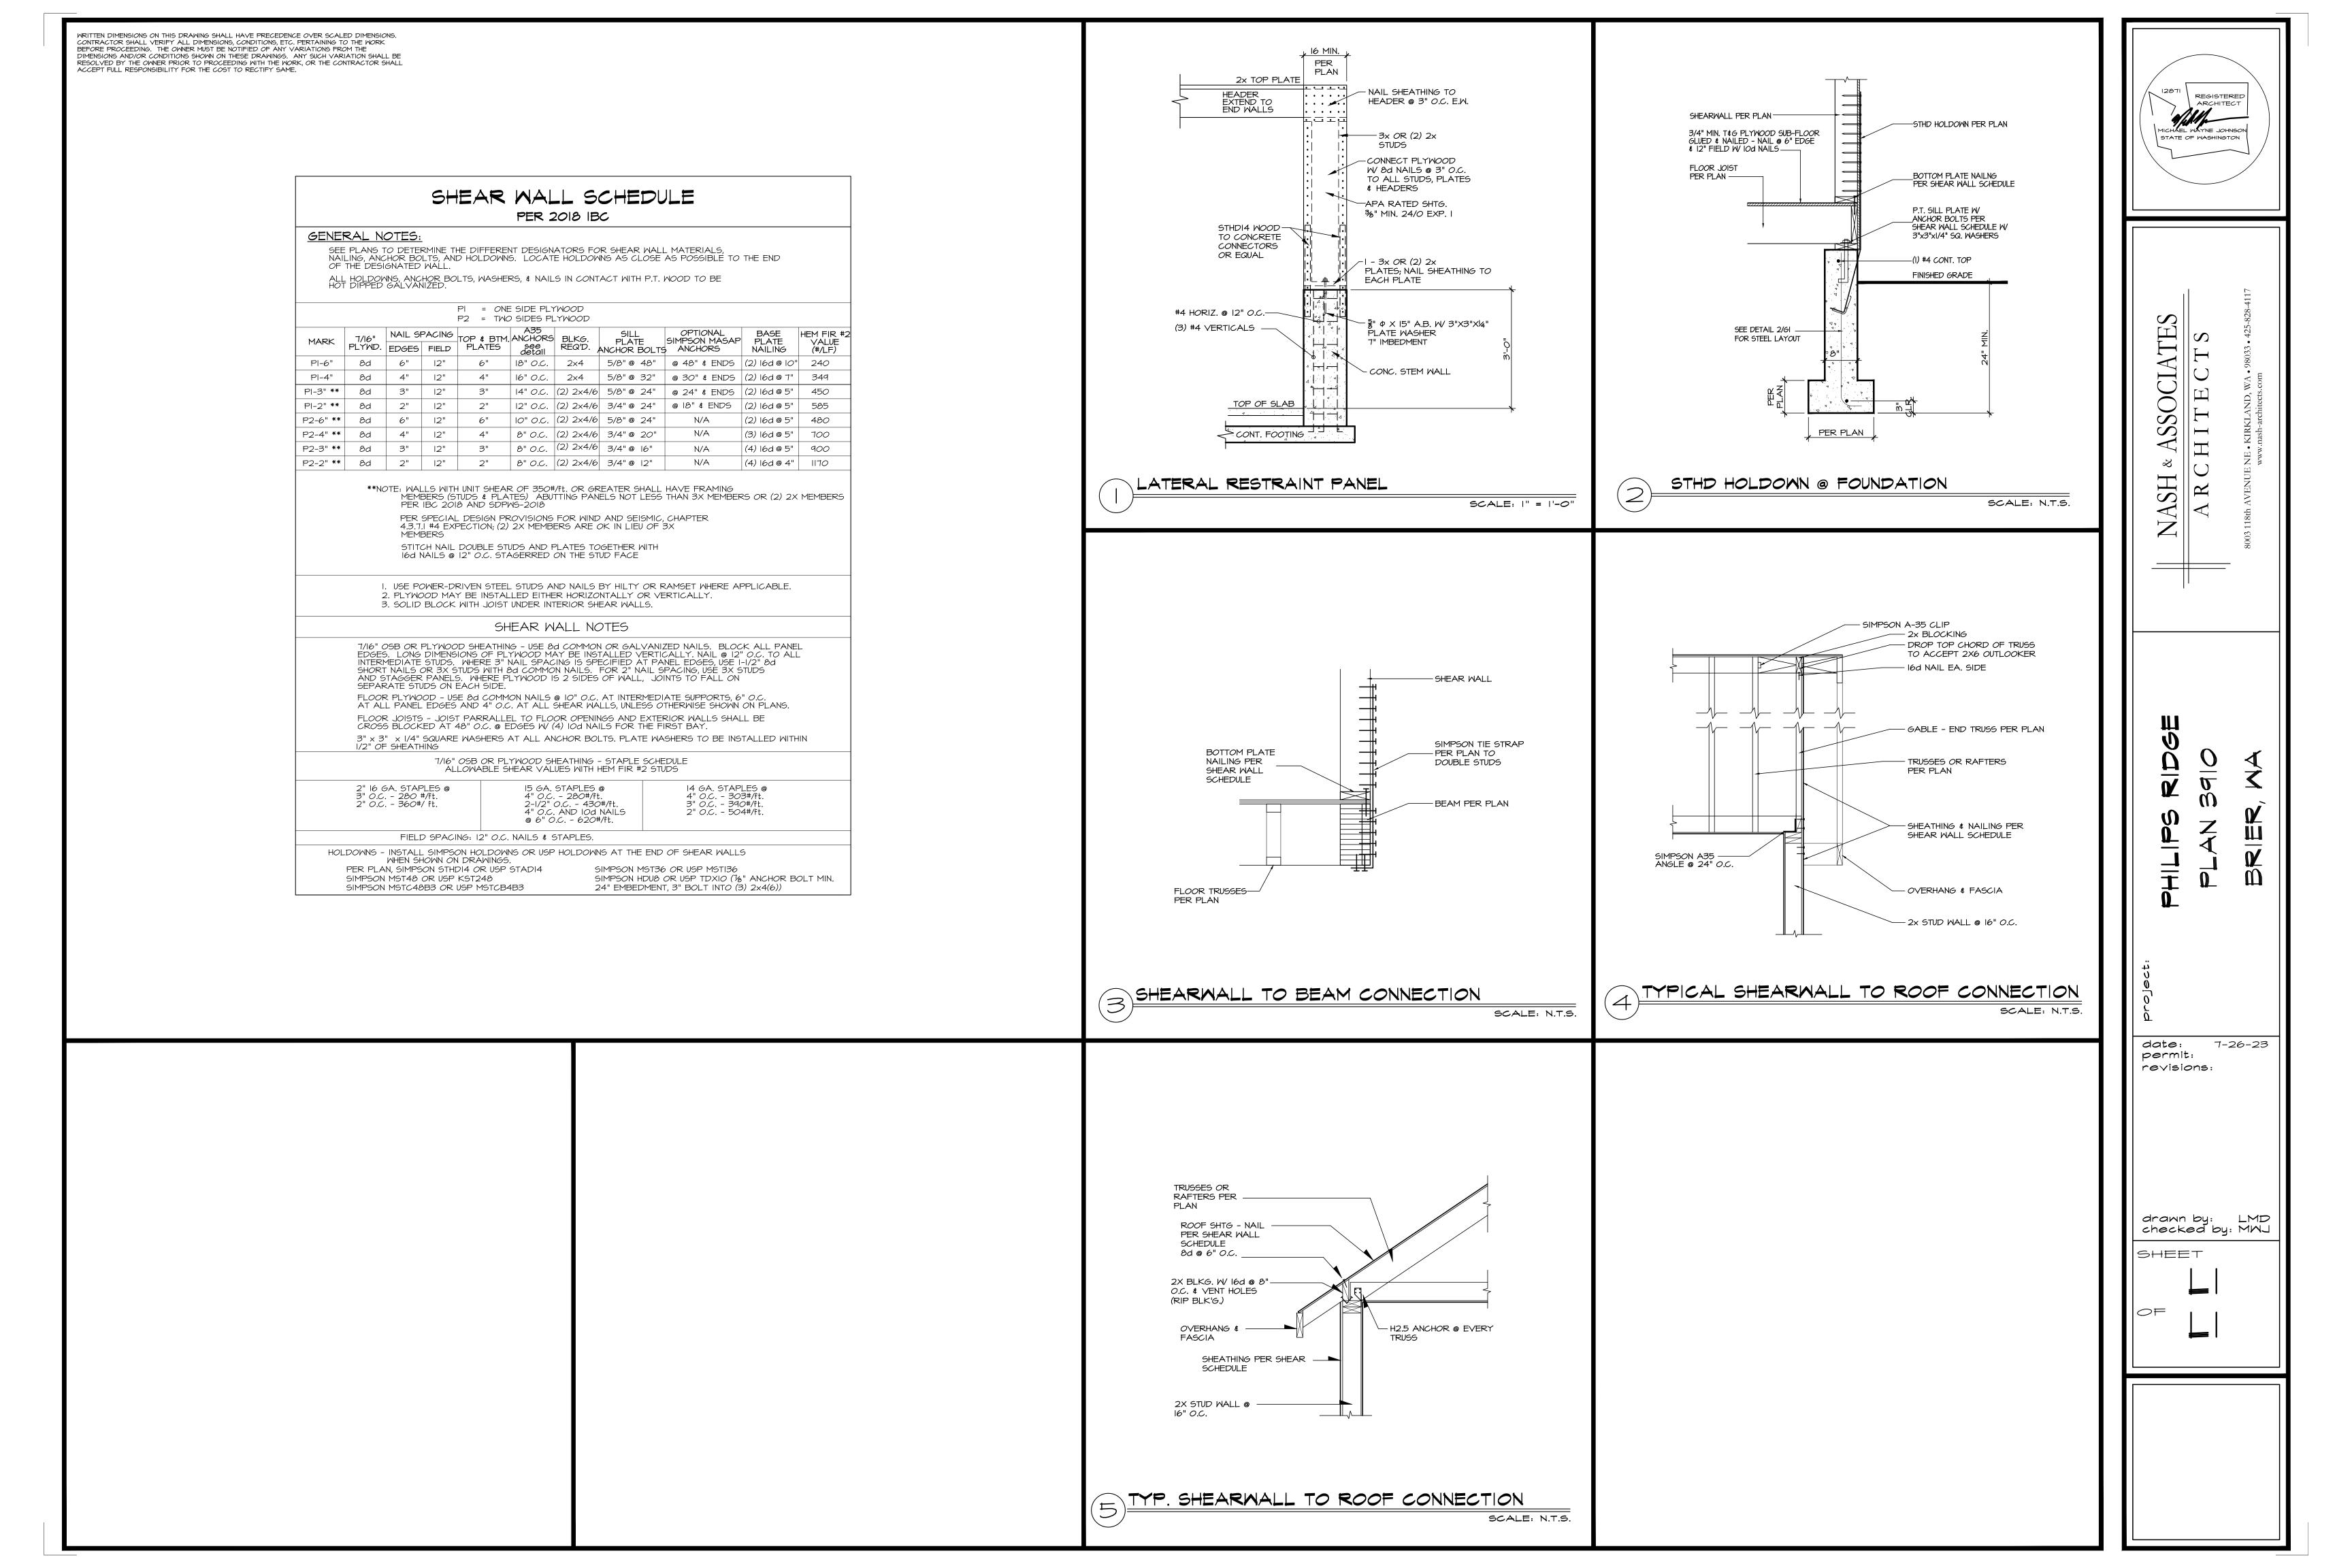
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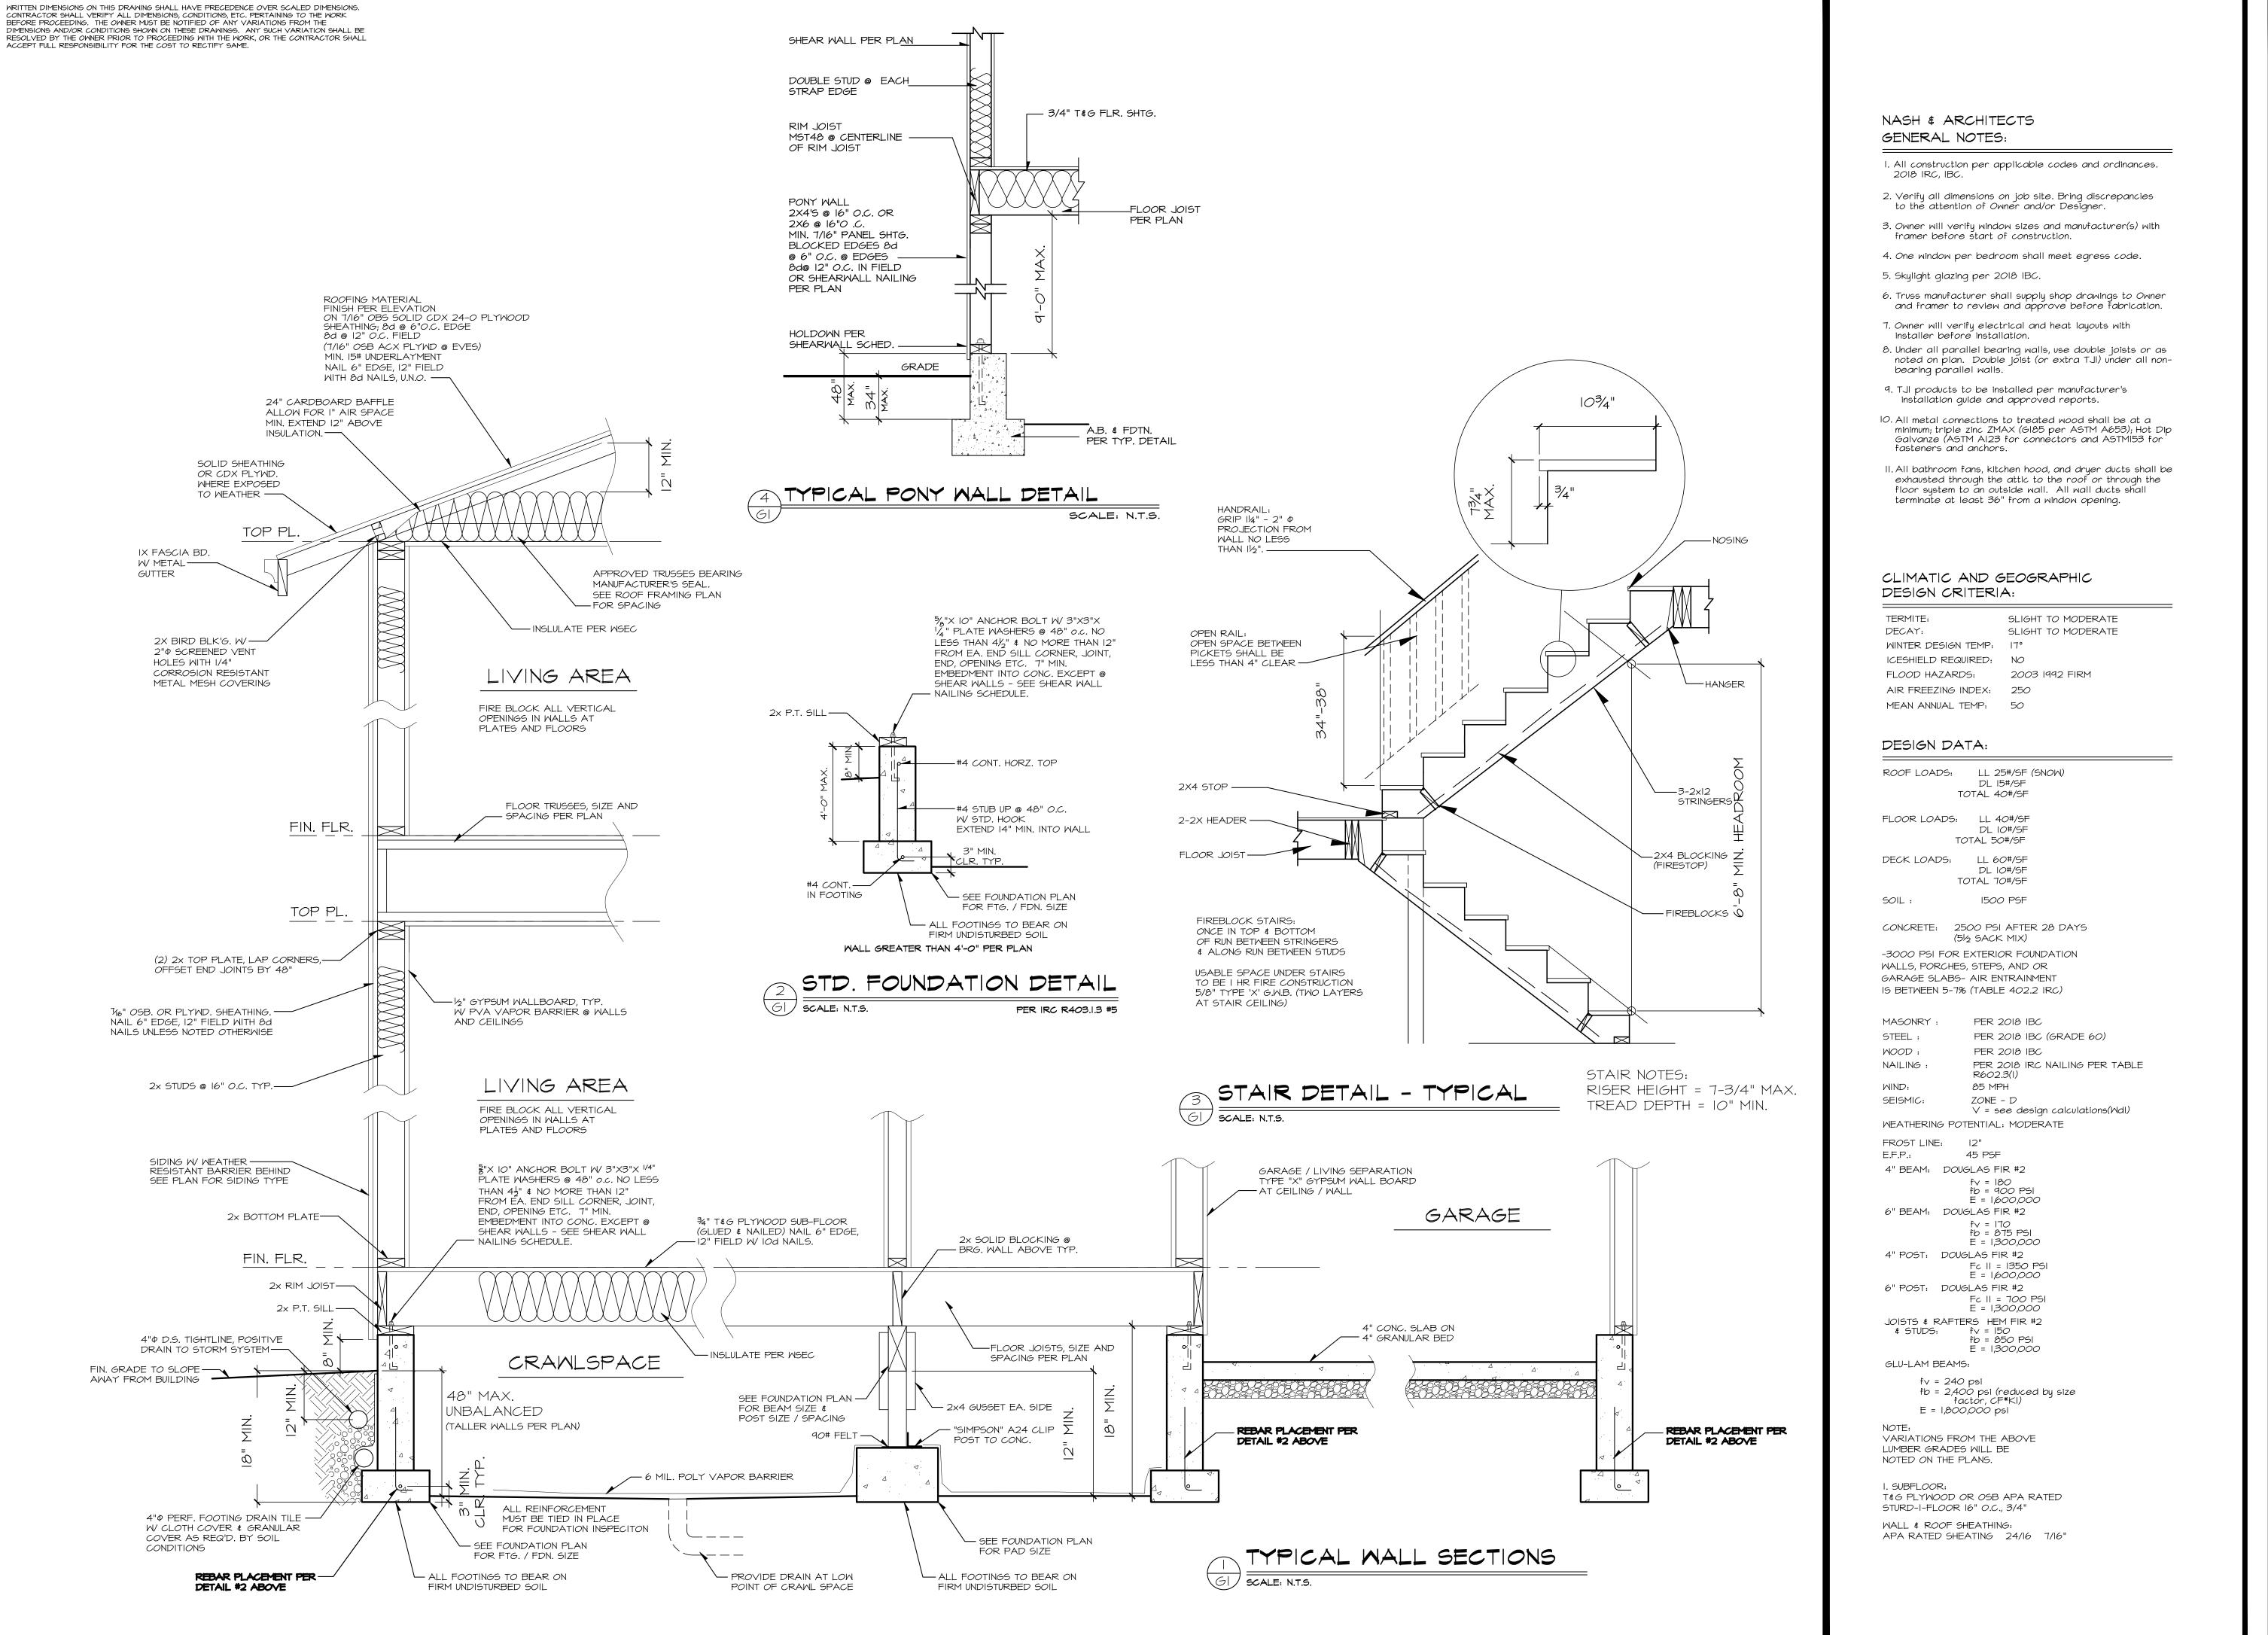
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TOTAL

6.0 CREDITS







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date:

permit: revisions:

7-26-23

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